

P2024-30 - Appendix 'B'

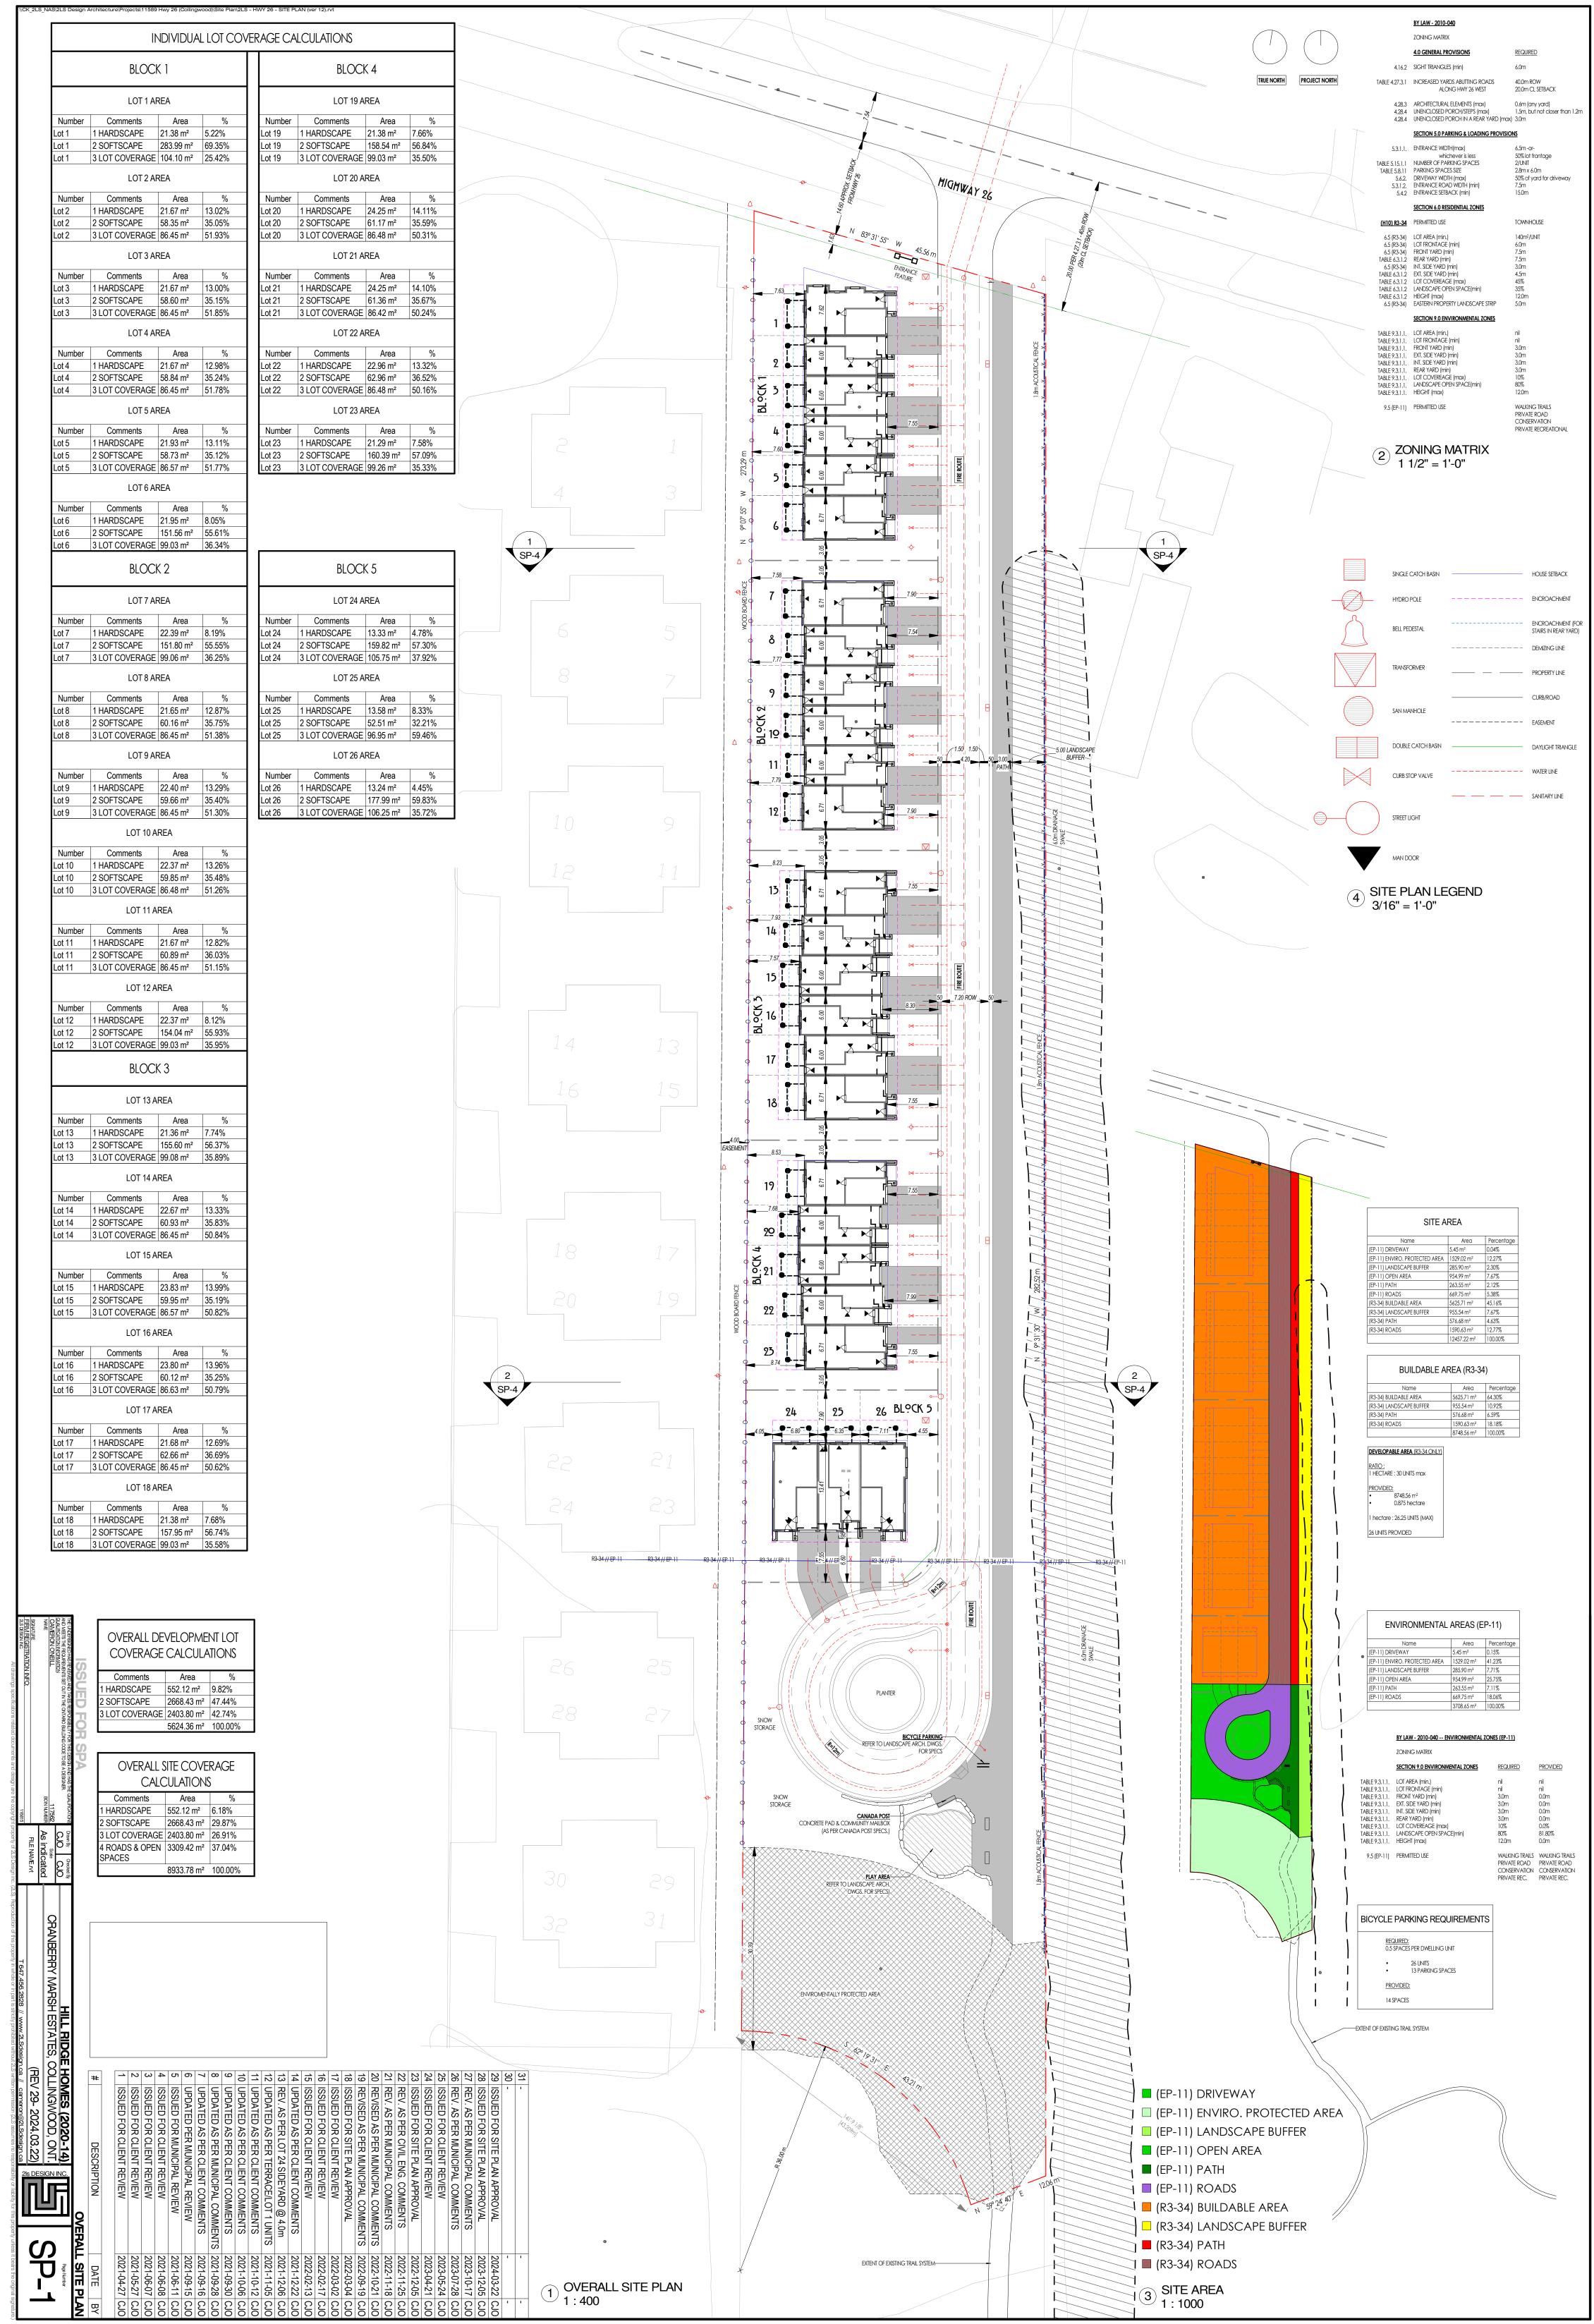


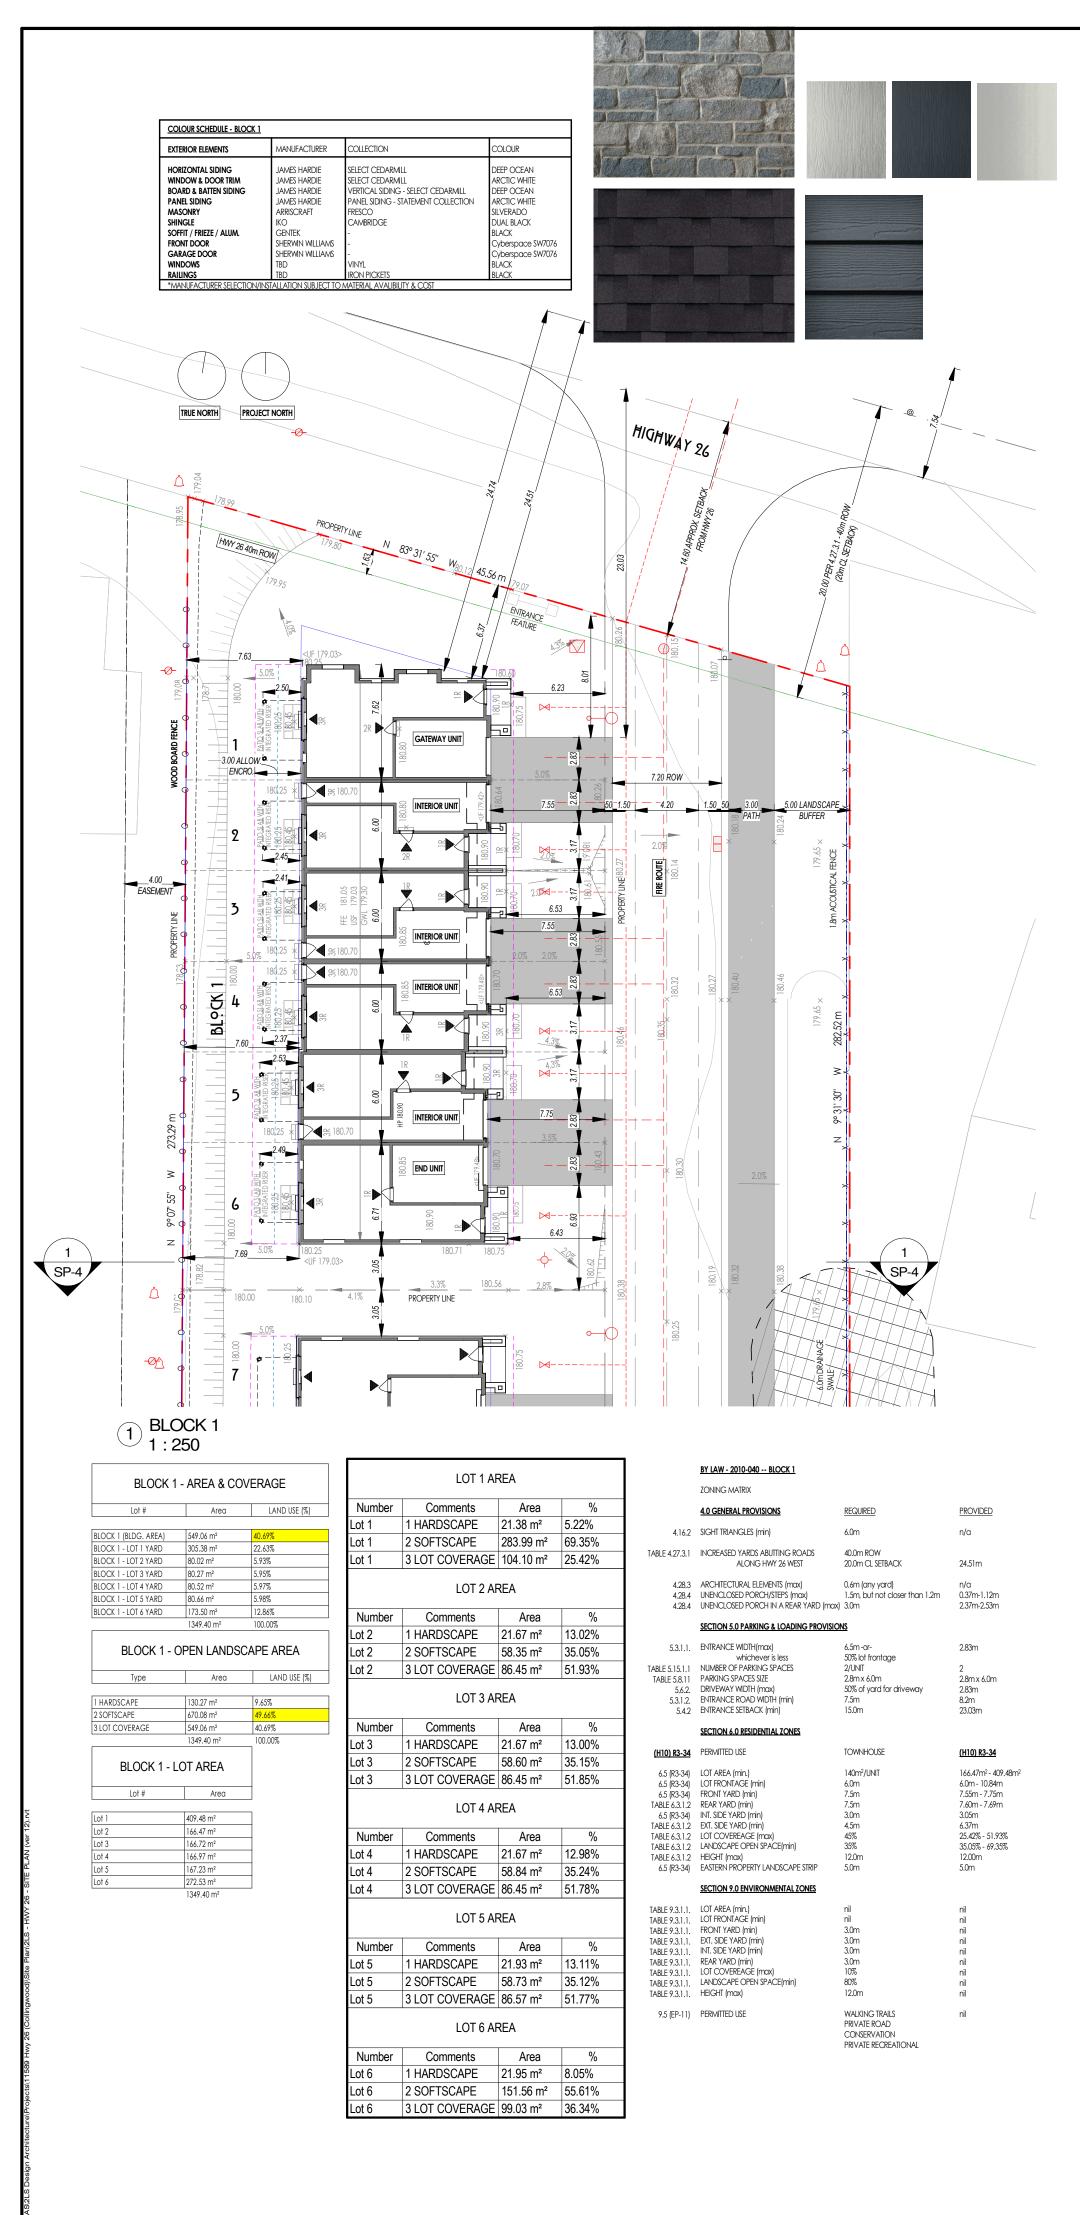

COLOUR SCHEDULE - BLOCK 2			
EXTERIOR ELEMENTS	MANUFACTURER	COLLECTION	COLOUR
HORIZONTAL SIDING	JAMES HARDIE	SELECT CEDARMILL	BOOTHBAY BLUE
WINDOW & DOOR TRIM	JAMES HARDIE	SELECT CEDARMILL	ARCTIC WHITE
BOARD & BATTEN SIDING	JAMES HARDIE	VERTICAL SIDING - SELECT CEDARMILL	BOOTHBAY BLUE
PANEL SIDING	JAMES HARDIE	PANEL SIDING - STATEMENT COLLECTION	ARCTIC WHITE
MASONRY	ARRISCRAFT	CITADEL	TRADITIONAL GREY
SHINGLE	IKO	CAMBRIDGE	DUAL BLACK
Soffit / Frieze / Alum.	GENTEK	-	BLACK
FRONT DOOR	SHERWIN WILLIAMS	-	Mountain Pass SW9655
GARAGE DOOR	SHERWIN WILLIAMS		Mountain Pass SW9655
WINDOWS	TBD	VINYL	BLACK
RAILINGS	TBD	IRON PICKETS	BLACK



MANUFACTURE
JAWES HARDIE JAWES HARDIE JAWES HARDIE JAWES HARDIE ARRISCRAFT IKO GENTEK SHERWIN WILLIA SHERWIN WILLIA TBD

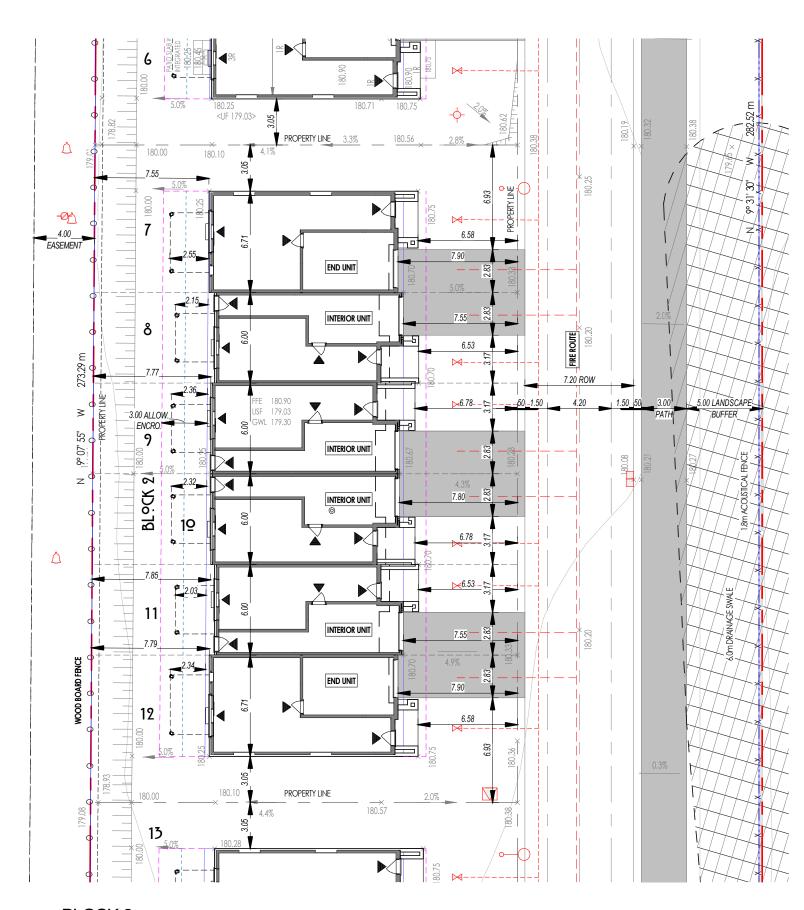


2 BLOCK 2 1 : 250

BLOCK 2	2 - AREA & CO	OVERAGE
Lot #	Area	LAND USE (%)
		· · ·
BLOCK 2 (BLDG. AREA)	543.92 m ²	44.47%
BLOCK 2 - LOT 7 YARD	174.19 m ²	14.24%
BLOCK 2 - LOT 8 YARD	81.81 m ²	6.69%
BLOCK 2 - LOT 9 YARD	82.06 m ²	6.71%
BLOCK 2 - LOT 10 YARD	82.21 m ²	6.72%
BLOCK 2 - LOT 11 YARD	82.55 m ²	6.75%
BLOCK 2 - LOT 12 YARD	176.41 m ²	14.42%
	1223.16 m ²	100.00%
BLOCK 2 - O	Area	LAND USE (%
Туре	Area	LAND USE (%
Type	Area 132.85 m ²	LAND USE (%
Type I HARDSCAPE 2 SOFTSCAPE	Area 132.85 m ² 546.40 m ²	LAND USE (%
Type HARDSCAPE 2 SOFTSCAPE	Area 132.85 m ²	LAND USE (%
Type 1 HARDSCAPE 2 SOFISCAPE 3 LOT COVERAGE BLOCK 2 - 1	Area 132.85 m ² 546.40 m ² 543.92 m ² 1223.16 m ² LOT AREA	LAND USE (% 10.86% 44.67% 44.47%
Type 1 HARDSCAPE 2 SOFTSCAPE 3 LOT COVERAGE	Area 132.85 m ² 546.40 m ² 543.92 m ² 1223.16 m ²	LAND USE (% 10.86% 44.67% 44.47%
Type 1 HARDSCAPE 2 SOFISCAPE 3 LOT COVERAGE BLOCK 2 - 1	Area 132.85 m ² 546.40 m ² 543.92 m ² 1223.16 m ² LOT AREA	LAND USE (% 10.86% 44.67% 44.47%
Type 1 HARDSCAPE 2 SOFTSCAPE 3 LOT COVERAGE BLOCK 2 - 1 Lot # .ot 7	Area 132.85 m ² 546.40 m ² 543.92 m ² 1223.16 m ² LOT AREA Area	LAND USE (% 10.86% 44.67% 44.47%
Type HARDSCAPE 2 SOFISCAPE 3 LOT COVERAGE BLOCK 2 - L Lot #	Area 132.85 m ² 546.40 m ² 543.92 m ² 1223.16 m ² LOT AREA Area 273.25 m ²	LAND USE (% 10.86% 44.67% 44.47%
Type 1 HARDSCAPE 2 SOFTSCAPE 3 LOT COVERAGE BLOCK 2 - 1 Lot #	Area 132.85 m ² 546.40 m ² 543.92 m ² 1223.16 m ² LOT AREA Area 273.25 m ² 168.26 m ²	LAND USE (% 10.86% 44.67% 44.47%
Type 1 HARDSCAPE 2 SOFTSCAPE 3 LOT COVERAGE BLOCK 2 - 1 Lot # Lot 7 Lot 8 Lot 9	Area 132.85 m ² 546.40 m ² 543.92 m ² 1223.16 m ² LOT AREA Area 273.25 m ² 168.26 m ² 168.51 m ²	LAND USE (% 10.86% 44.67% 44.47%

	LOT 7 AF	REA		
Number	Comments	Area	%	
Lot 7	1 HARDSCAPE	22.39 m ²	8.19%	
Lot 7	2 SOFTSCAPE	151.80 m ²	55.55%	4.16
Lot 7	3 LOT COVERAGE	99.06 m²	36.25%	TABLE 4.27.3
	LOT 8 AF	REA		4.28 4.28
Number	Comments	Area	%	4.28
Lot 8	1 HARDSCAPE	21.65 m²	12.87%	
Lot 8	2 SOFTSCAPE	60.16 m²	35.75%	5.3.1
Lot 8	3 LOT COVERAGE	86.45 m²	51.38%	TABLE 5.15.1
	LOT 9 AF	REA		TABLE 5.8. 5.6 5.3.1
Number	Comments	Area	%	5.4
Lot 9	1 HARDSCAPE	22.40 m ²	13.29%	
Lot 9	2 SOFTSCAPE	59.66 m²	35.40%	<u>(H10) R3-</u>
Lot 9	3 LOT COVERAGE	86.45 m²	51.30%	6.5 (R3-3
	LOT 10 A	REA		6.5 (R3-3 6.5 (R3-3 TABLE 6.3.1 6.5 (R3-3
Number	Comments	Area	%	TABLE 6.3.1 TABLE 6.3.1
Lot 10	1 HARDSCAPE	22.37 m²	13.26%	TABLE 6.3.1
Lot 10	2 SOFTSCAPE	59.85 m²	35.48%	TABLE 6.3.1 6.5 (R3-3
Lot 10	3 LOT COVERAGE	86.48 m²	51.26%	
	LOT 11 A	REA		TABLE 9.3.1 TABLE 9.3.1
Number	Comments	Area	%	TABLE 9.3.1 TABLE 9.3.1
Lot 11	1 HARDSCAPE	21.67 m²	12.82%	TABLE 9.3.1 TABLE 9.3.1
Lot 11	2 SOFTSCAPE	60.89 m²	36.03%	TABLE 9.3.1 TABLE 9.3.1
Lot 11	3 LOT COVERAGE	86.45 m²	51.15%	TABLE 9.3.1
	LOT 12 A	REA		9.5 (EP-1
Number	Comments	Area	%	
Lot 12	1 HARDSCAPE	22.37 m²	8.12%	
Lot 12	2 SOFTSCAPE	154.04 m²	55.93%	
Lot 12	3 LOT COVERAGE	99.03 m²	35.95%	

ZONING MATRIX		
4.0 GENERAL PROVISIONS	REQUIRED	PROVIDED
SIGHT TRIANGLES (min)	6.0m	n/a
INCREASED YARDS ABUTTING ROADS ALONG HWY 26 WEST	40.0m ROW 20.0m CL SETBACK	n/a
ARCHITECTURAL ELEMENTS (max) UNENCLOSED PORCH/STEPS (max) UNENCLOSED PORCH IN A REAR YARD (max)	0.6m (any yard) 1.5m, but not closer than 1.2m 3.0m	n/a n/a 2.03m-2.55m
SECTION 5.0 PARKING & LOADING PROVISION	<u>vs</u>	
	50% of yard for driveway	2.83m 2 2.8m x 6.0m 2.83m 8.2m n/a
SECTION 6.0 RESIDENTIAL ZONES		
PERMITTED USE	TOWNHOUSE	<u>(H10) R3-34</u>
INT. SIDE YARD (min)	3.0m	168.26m ² - 275.44m ² 6.0m - 9.76m 7.55m - 7.90m 7.55m - 7.85m 3.05m n/a 35.95% - 51.83% 35.40% - 55.93% 11.96m (estimated) 5.0m
SECTION 9.0 ENVIRONMENTAL ZONES		
LANDSCAPE OPEN SPACE(min)	nil nil 3.0m 3.0m 3.0m 1.0% 80% 12.0m WALKING TRAILS	nil nil nil nil nil nil nil nil
	SIGHT TRIANGLES (min) INCREASED YARDS ABUTTING ROADS ALONG HWY 26 WEST ARCHITECTURAL ELEMENTS (max) UNENCLOSED PORCH/STEPS (max) UNENCLOSED PORCH IN A REAR YARD (max) SECTION 5.0 PARKING & LOADING PROVISION ENTRANCE WIDTH(max) whichever is less NUMBER OF PARKING SPACES PARKING SPACES SIZE DRIVEWAY WIDTH (max) ENTRANCE ROAD WIDTH (min) ENTRANCE ROAD WIDTH (min) ENTRANCE SETBACK (min) SECTION 5.0 RESIDENTIAL ZONES PERWITTED USE LOT AREA (min.) LOT FRONTAGE (min) REAR YARD (min) ENT. SIDE YARD (min) EXT. SIDE YARD (min) INT. SIDE YARD (min) EXT. SIDE YARD (min) INT. SIDE YARD (min) EXT.	SIGHT TRIANGLES (min)6.0mINCREASED YARDS ABUTTING ROADS ALONG HWY 26 WEST20.0m CL SETBACKARCHTECTURAL ELEMENTS (max)0.6m (any yard)UNENCLOSED PORCH/STEPS (max)1.5m, but not closer than 1.2mUNENCLOSED PORCH IN A REAR YARD (max)3.0mSECTION 5.0 PARKING & LOADING PROVISIONSECTION 5.0 PARKING & LOADING PROVISIONPARKING SPACES2.0/WITPARKING SPACE (min)7.5mPARKING SPACE (min)PARKING SPACE (min)7.5mPARKING SPACE (min)SUTON 6.0 ERSIDENTIAL ZONESLOT AREA (min)

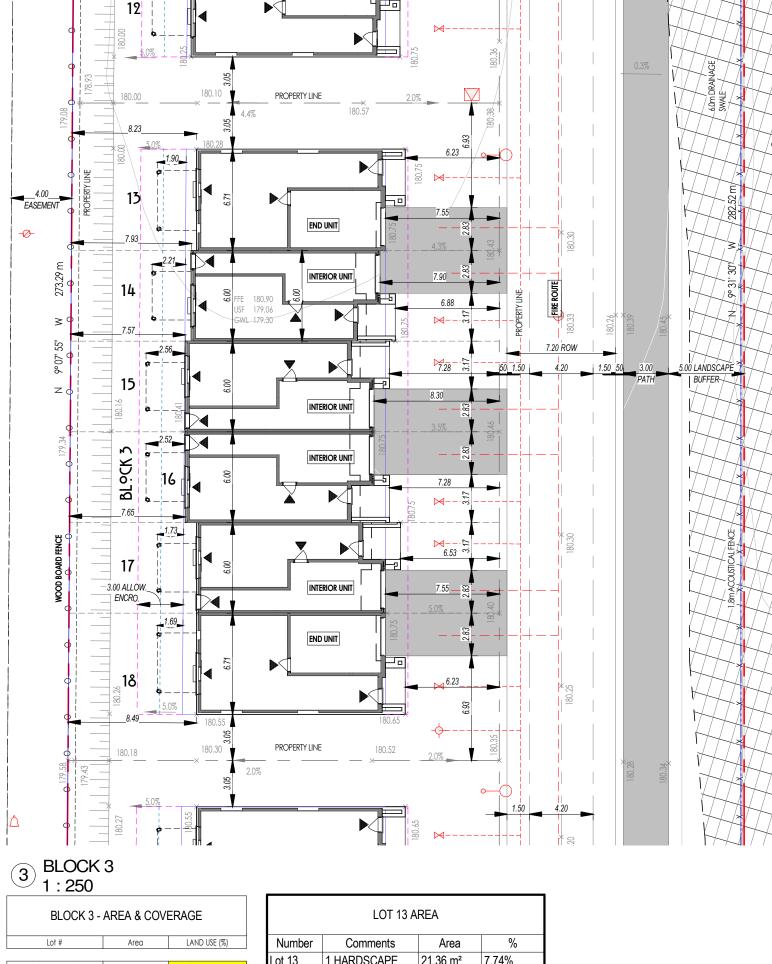

BLOCK 3 (BLDG. AREA)	544.21 m ²
BLOCK 3 - LOT 13 YARD	176.96 m ²
BLOCK 3 - LOT 14 YARD	83.60 m ²
BLOCK 3 - LOT 15 YARD	83.79 m ²
BLOCK 3 - LOT 16 YARD	83.92 m ²
BLOCK 3 - LOT 17 YARD	84.35 m ²
BLOCK 3 - LOT 18 YARD	179.33 m ²
	1236.15 m ²

BLOCK 3	- OPEN LANDS	CAPE AREA
Туре	Area	LAND USE (%)
1 HARDSCAPE	134.73 m ²	10.90%
2 SOFTSCAPE	557.21 m ²	45.08%
3 LOT COVERAGE	544.21 m ²	44.02%
	1236.15 m ²	100.00%
Lot #	Area	_
Lot 13	276.05 m ²	
Lot 14	170.05 m ²	
Lot 15	170.35 m ²	
Lot 16	170.55 m ²	
Lot 17	170.80 m ²	
Lot 18	278.35 m ²	
	1236.15 m ²	



	B	3Y LAW - 2010-040 BLOCK 3			
	Z	ONING MATRIX			
	4	1.0 GENERAL PROVISIONS	REQUIRED	PROVIDED	
4.16	.2 S	IGHT TRIANGLES (min)	6.0m	n/a	
LE 4.27.3	.1 11	NCREASED YARDS ABUTTING ROADS ALONG HWY 26 WEST	40.0m ROW 20.0m CL SETBACK	n/a	
4.28	.4 l	ARCHITECTURAL ELEMENTS (max) INENCLOSED PORCH/STEPS (max) INENCLOSED PORCH IN A REAR YARD (max)	0.6m (any yard) 1.5m, but not closer than 1.2m 3.0m	n/a n/a 1.90m-2.56m	
	<u>s</u>	ECTION 5.0 PARKING & LOADING PROVISION	<u>vs</u>		
BLE 5.8.1 5.6. 5.3.1.	.1 M 11 F 2. C 2. E	PARKING SPACES SIZE DRIVEWAY WIDTH (max) ENTRANCE ROAD WIDTH (min)	6.5m -or- 50% lot frontage 2/UNIT 2.8m x 6.0m 50% of yard for driveway 7.5m 15.0m	2.83m 2 2.8m x 6.0m 2.83m 8.2m n/a	
	<u>s</u>	ECTION 6.0 RESIDENTIAL ZONES			
110) R3-3	<u>34</u> F	PERMITTED USE	TOWNHOUSE	<u>(H10) R3-34</u>	
6.5 (R3-3 6.5 (R3-3 6.5 (R3-3 BLE 6.3.1 6.5 (R3-3 BLE 6.3.1 BLE 6.3.1 BLE 6.3.1 BLE 6.3.1 6.5 (R3-3	4) L 4) F .2 R 4) II .2 E .2 L .2 L .2 H	RONT YARD (min) REAR YARD (min) NT. SIDE YARD (min) XT. SIDE YARD (min)	140m²/UNIT 6.0m 7.5m 7.5m 3.0m 4.5m 4.5m 55% 12.0m 5.0m	170.05m ² - 278.3 6.0m - 9.76m 7.55m - 8.30m 7.57m - 8.49m 3.05m n/a 35.58% - 50.84% 35.19% - 56.74% 11.96m (estimo 5.0m	,
	<u>s</u>	ECTION 9.0 ENVIRONMENTAL ZONES			
BLE 9.3.1. BLE 9.3.1. BLE 9.3.1. BLE 9.3.1. BLE 9.3.1. BLE 9.3.1. BLE 9.3.1. BLE 9.3.1. BLE 9.3.1. BLE 9.3.1.	1. L 1. F 1. E 1. II 1. R 1. L 1. L 1. L	NT. SIDE YARD (min) REAR YARD (min) OT COVEREAGE (mox) ANDSCAPE OPEN SPACE(min)	nil nil 3.0m 3.0m 3.0m 3.0m 10% 80% 12.0m WALKING TRAILS PRIVATE ROAD	nil nil nil nil nil nil nil nil	
			CONSERVATION PRIVATE RECREATIONAL		
	31	-		-	-
	30	-		-	-
	29	ISSUED FOR SITE PLAN	APPROVAL	2024-03-22	CJO

28 IS 27 R 26 R 25 IS 24 IS 23 IS 24 IS 23 IS 24 IS 23 IS 24 IS 25 R 20 R 19 R 15 IS 14 U 13 R 14 U 13 R 14 U 15 IS 16 IS 17 U 18 U 19 U 11 U 12 U 13 R 14 U 15 IS 16 U 15 IS 16 U 15 IS	SSUED FOR SITE PLAN APPROVAL SSUED FOR SITE PLAN APPROVAL REV. AS PER MUNICIPAL COMMENTS REV. AS PER MUNICIPAL COMMENTS SSUED FOR CLIENT REVIEW SSUED FOR CLIENT REVIEW SSUED FOR SITE PLAN APPROVAL REV. AS PER CIVIL ENG. COMMENTS REV. AS PER MUNICIPAL COMMENTS REVISED AS PER MUNICIPAL COMMENTS REVISED AS PER MUNICIPAL COMMENTS SSUED FOR SITE PLAN APPROVAL SSUED FOR SITE PLAN APPROVAL SSUED FOR SITE PLAN APPROVAL SSUED FOR CLIENT REVIEW SSUED FOR CLIENT REVIEW SSUED FOR CLIENT REVIEW SSUED FOR CLIENT REVIEW JPDATED AS PER CLIENT COMMENTS REV. AS PER LOT 24 SIDEYARD @ 4.0m JPDATED AS PER TERRACE/LOT 1 UNITS	- 2024-03-22 2023-12-05 2023-07-28 2023-07-28 2023-05-24 2023-04-21 2022-12-05 2022-11-25 2022-11-25 2022-10-21 2022-09-19 2022-03-04 2022-03-04 2022-03-02 2022-02-17 2022-02-13 2021-12-22 2021-12-06	CJO CJO CJO CJO CJO CJO CJO CJO CJO CJO
28 IS 27 R 26 R 25 IS 24 IS 23 IS 24 IS 23 IS 24 IS 23 IS 24 IS 25 R 20 R 19 R 15 IS 14 U 13 R 14 U 13 R 14 U 15 IS 16 IS 17 U 18 U 19 U 11 U 12 U 13 R 14 U 15 IS 16 U 15 IS 16 U 15 IS	SSUED FOR SITE PLAN APPROVAL REV. AS PER MUNICIPAL COMMENTS REV. AS PER MUNICIPAL COMMENTS SSUED FOR CLIENT REVIEW SSUED FOR CLIENT REVIEW SSUED FOR SITE PLAN APPROVAL REV. AS PER CIVIL ENG. COMMENTS REV. AS PER MUNICIPAL COMMENTS REVISED AS PER MUNICIPAL COMMENTS REVISED AS PER MUNICIPAL COMMENTS SSUED FOR SITE PLAN APPROVAL SSUED FOR CLIENT REVIEW SSUED FOR CLIENT REVIEW JPDATED AS PER CLIENT COMMENTS REV. AS PER LOT 24 SIDEYARD @ 4.0m	2023-12-05 2023-10-17 2023-07-28 2023-05-24 2023-04-21 2022-12-05 2022-11-25 2022-11-25 2022-10-21 2022-09-19 2022-03-04 2022-03-04 2022-02-17 2022-02-13 2021-12-22	CJO CJO CJO CJO CJO CJO CJO CJO CJO CJO
27 R 26 R 25 IS 24 IS 23 IS 24 IS 23 IS 24 IS 23 IS 24 IS 25 IS 26 R 27 R 19 R 10 IS 11 U 12 U 13 R 14 U 13 R 14 U 13 R 14 U 15 IS 16 IS 17 U 10 U 9 U 10 U 9 U 16 U 17 U 18 U 19 U 10 G	REV. AS PER MUNICIPAL COMMENTS REV. AS PER MUNICIPAL COMMENTS SSUED FOR CLIENT REVIEW SSUED FOR CLIENT REVIEW SSUED FOR SITE PLAN APPROVAL REV. AS PER CIVIL ENG. COMMENTS REV. AS PER MUNICIPAL COMMENTS REVISED AS PER MUNICIPAL COMMENTS REVISED AS PER MUNICIPAL COMMENTS SSUED FOR SITE PLAN APPROVAL SSUED FOR CLIENT REVIEW SSUED FOR CLIENT REVIEW SSUED FOR CLIENT REVIEW JPDATED AS PER CLIENT COMMENTS REV. AS PER LOT 24 SIDEYARD @ 4.0m	2023-10-17 2023-07-28 2023-05-24 2023-04-21 2022-12-05 2022-11-25 2022-11-25 2022-10-21 2022-09-19 2022-03-04 2022-03-02 2022-02-17 2022-02-13 2021-12-22	CJO CJO CJO CJO CJO CJO CJO CJO CJO CJO
26 R 25 IS 24 IS 23 IS 24 IS 22 R 21 R 20 R 19 R 17 IS 16 IS 15 IS 14 U 13 R 14 U 13 R 14 U 13 R 14 U 15 IS 16 IS 17 U 18 U 19 U 10 U 9 U 6 U 5 IS 4 IS	REV. AS PER MUNICIPAL COMMENTS SSUED FOR CLIENT REVIEW SSUED FOR CLIENT REVIEW SSUED FOR SITE PLAN APPROVAL REV. AS PER CIVIL ENG. COMMENTS REV. AS PER MUNICIPAL COMMENTS REVISED AS PER MUNICIPAL COMMENTS REVISED AS PER MUNICIPAL COMMENTS SSUED FOR SITE PLAN APPROVAL SSUED FOR CLIENT REVIEW SSUED FOR CLIENT REVIEW SSUED FOR CLIENT REVIEW JPDATED AS PER CLIENT COMMENTS REV. AS PER LOT 24 SIDEYARD @ 4.0m	2023-07-28 2023-05-24 2023-04-21 2022-12-05 2022-11-25 2022-11-18 2022-03-01 2022-03-04 2022-03-04 2022-02-17 2022-02-13 2021-12-22	CJO CJO CJO CJO CJO CJO CJO CJO CJO CJO
25 IS 24 IS 23 IS 22 R 21 R 20 R 19 R 17 IS 18 IS 17 IS 18 IS 15 IS 14 U 13 R 14 U 13 R 14 U 15 IS 16 IS 17 U 13 R 14 U 15 U 16 U 17 U 18 U 19 U 10 U 11 U 12 U 13 R 14 U 15 IS 16 U 15 IS </td <td>SSUED FOR CLIENT REVIEW SSUED FOR CLIENT REVIEW SSUED FOR SITE PLAN APPROVAL REV. AS PER CIVIL ENG. COMMENTS REV. AS PER MUNICIPAL COMMENTS REVISED AS PER MUNICIPAL COMMENTS REVISED AS PER MUNICIPAL COMMENTS SSUED FOR SITE PLAN APPROVAL SSUED FOR CLIENT REVIEW SSUED FOR CLIENT REVIEW SSUED FOR CLIENT REVIEW JPDATED AS PER CLIENT COMMENTS REV. AS PER LOT 24 SIDEYARD @ 4.0m</td> <td>2023-05-24 2023-04-21 2022-12-05 2022-11-25 2022-10-21 2022-09-19 2022-03-04 2022-03-02 2022-02-17 2022-02-13 2021-12-22</td> <td>CJO CJO CJO CJO CJO CJO CJO CJO CJO</td>	SSUED FOR CLIENT REVIEW SSUED FOR CLIENT REVIEW SSUED FOR SITE PLAN APPROVAL REV. AS PER CIVIL ENG. COMMENTS REV. AS PER MUNICIPAL COMMENTS REVISED AS PER MUNICIPAL COMMENTS REVISED AS PER MUNICIPAL COMMENTS SSUED FOR SITE PLAN APPROVAL SSUED FOR CLIENT REVIEW SSUED FOR CLIENT REVIEW SSUED FOR CLIENT REVIEW JPDATED AS PER CLIENT COMMENTS REV. AS PER LOT 24 SIDEYARD @ 4.0m	2023-05-24 2023-04-21 2022-12-05 2022-11-25 2022-10-21 2022-09-19 2022-03-04 2022-03-02 2022-02-17 2022-02-13 2021-12-22	CJO CJO CJO CJO CJO CJO CJO CJO CJO
24 IS 23 IS 22 R 21 R 20 R 19 R 19 R 119 IS 16 IS 17 IS 18 IS 110 IS 111 U 112 U 111 U 110 U 110 U 111 U 112 U 113 R 114 U 115 IS 116 IS 117 U 110 U 111 U 112 U 113 R 114 U 115 IS 116 IS 117 U 118 IS 119 U 110	SSUED FOR CLIENT REVIEW SSUED FOR SITE PLAN APPROVAL REV. AS PER CIVIL ENG. COMMENTS REV. AS PER MUNICIPAL COMMENTS REVISED AS PER MUNICIPAL COMMENTS SSUED FOR SITE PLAN APPROVAL SSUED FOR CLIENT REVIEW SSUED FOR CLIENT REVIEW	2023-04-21 2022-12-05 2022-11-25 2022-11-18 2022-09-19 2022-03-04 2022-03-02 2022-02-17 2022-02-13 2021-12-22	CJO CJO CJO CJO CJO CJO CJO CJO
23 IS 22 R 21 R 20 R 19 R 18 IS 17 IS 18 IS 17 IS 15 IS 14 U 13 R 12 U 11 U 10 U 9 U 8 U 7 U 6 U 5 IS 4 IS	SSUED FOR SITE PLAN APPROVAL REV. AS PER CIVIL ENG. COMMENTS REV. AS PER MUNICIPAL COMMENTS REVISED AS PER MUNICIPAL COMMENTS SSUED FOR SITE PLAN APPROVAL SSUED FOR CLIENT REVIEW SSUED FOR CLIENT REVIEW SSUED FOR CLIENT REVIEW JPDATED AS PER CLIENT COMMENTS REV. AS PER LOT 24 SIDEYARD @ 4.0m	2022-12-05 2022-11-25 2022-10-21 2022-09-19 2022-03-04 2022-03-02 2022-02-17 2022-02-13 2022-02-13	CJO CJO CJO CJO CJO CJO CJO
22 R 21 R 20 R 19 R 18 IS 17 IS 16 IS 15 IS 14 U 13 R 12 U 11 U 10 U 9 U 8 U 7 U 6 U 5 IS 15 IS 16 IS 17 IS 10 IS	REV. AS PER CIVIL ENG. COMMENTS REV. AS PER MUNICIPAL COMMENTS REVISED AS PER MUNICIPAL COMMENTS REVISED AS PER MUNICIPAL COMMENTS SSUED FOR SITE PLAN APPROVAL SSUED FOR CLIENT REVIEW SSUED FOR CLIENT REVIEW SSUED FOR CLIENT REVIEW JPDATED AS PER CLIENT COMMENTS REV. AS PER LOT 24 SIDEYARD @ 4.0m	2022-11-25 2022-10-21 2022-09-19 2022-03-04 2022-03-02 2022-02-17 2022-02-13 2021-12-22	CJO CJO CJO CJO CJO CJO CJO
21 R 20 R 19 R 18 IS 16 IS 15 IS 14 U 13 R 14 U 13 R 14 U 13 R 14 U 10 U 9 U 9 U 6 U 5 IS 4 IS	REV. AS PER MUNICIPAL COMMENTS REVISED AS PER MUNICIPAL COMMENTS REVISED AS PER MUNICIPAL COMMENTS SSUED FOR SITE PLAN APPROVAL SSUED FOR CLIENT REVIEW SSUED FOR CLIENT REVIEW SSUED FOR CLIENT REVIEW JPDATED AS PER CLIENT COMMENTS REV. AS PER LOT 24 SIDEYARD @ 4.0m	2022-11-18 2022-09-19 2022-03-04 2022-03-02 2022-02-17 2022-02-13 2021-12-22	CJO CJO CJO CJO CJO
20 R 19 R 18 IS 17 IS 16 IS 15 IS 14 U 13 R 14 U 13 R 14 U 15 U 16 U 17 U 10 U 9 U 8 U 7 U 6 U 5 IS 4 IS	REVISED AS PER MUNICIPAL COMMENTS REVISED AS PER MUNICIPAL COMMENTS SSUED FOR SITE PLAN APPROVAL SSUED FOR CLIENT REVIEW SSUED FOR CLIENT REVIEW SSUED FOR CLIENT REVIEW JPDATED AS PER CLIENT COMMENTS REV. AS PER LOT 24 SIDEYARD @ 4.0m	2022-10-21 2022-09-19 2022-03-04 2022-03-02 2022-02-17 2022-02-13 2021-12-22	CJO CJO CJO CJO CJO
19 R 18 IS 17 IS 16 IS 15 IS 14 U 13 R 12 U 11 U 12 U 11 U 9 U 8 U 7 U 6 U 5 IS 4 IS	REVISED AS PER MUNICIPAL COMMENTS SSUED FOR SITE PLAN APPROVAL SSUED FOR CLIENT REVIEW SSUED FOR CLIENT REVIEW SSUED FOR CLIENT REVIEW JPDATED AS PER CLIENT COMMENTS REV. AS PER LOT 24 SIDEYARD @ 4.0m	2022-09-19 2022-03-04 2022-03-02 2022-02-17 2022-02-13 2021-12-22	CJO CJO CJO
18 IS 17 IS 16 IS 15 IS 14 U 13 R 14 U 13 R 14 U 13 R 14 U 13 R 14 U 15 U 16 U 9 U 9 U 6 U 5 IS 4 IS	SSUED FOR SITE PLAN APPROVAL SSUED FOR CLIENT REVIEW SSUED FOR CLIENT REVIEW SSUED FOR CLIENT REVIEW JPDATED AS PER CLIENT COMMENTS REV. AS PER LOT 24 SIDEYARD @ 4.0m	2022-03-04 2022-03-02 2022-02-17 2022-02-13 2021-12-22	CJO CJO CJO
17 IS 16 IS 15 IS 14 U 13 R 12 U 11 U 10 U 9 U 8 U 7 U 6 U 5 IS 4 IS	SSUED FOR CLIENT REVIEW SSUED FOR CLIENT REVIEW SSUED FOR CLIENT REVIEW JPDATED AS PER CLIENT COMMENTS REV. AS PER LOT 24 SIDEYARD @ 4.0m	2022-03-02 2022-02-17 2022-02-13 2021-12-22	CJO CJO CJO
16 IS 15 IS 14 U 13 R 12 U 11 U 10 U 10 U 9 U 8 U 7 U 6 U 5 IS 4 IS	SSUED FOR CLIENT REVIEW SSUED FOR CLIENT REVIEW JPDATED AS PER CLIENT COMMENTS REV. AS PER LOT 24 SIDEYARD @ 4.0m	2022-02-17 2022-02-13 2021-12-22	CJO CJO
15 IS 14 U 13 R 12 U 11 U 10 U 9 U 8 U 7 U 6 U 5 IS 4 IS	SSUED FOR CLIENT REVIEW JPDATED AS PER CLIENT COMMENTS REV. AS PER LOT 24 SIDEYARD @ 4.0m	2022-02-13 2021-12-22	CJO
14 U 13 R 12 U 11 U 10 U 9 U 8 U 7 U 6 U 5 IS 4 IS	JPDATED AS PER CLIENT COMMENTS REV. AS PER LOT 24 SIDEYARD @ 4.0m	2021-12-22	
13 R 12 U 11 U 10 U 9 U 8 U 7 U 6 U 5 IS 4 IS	REV. AS PER LOT 24 SIDEYARD @ 4.0m		CIO
12 U 11 U 10 U 9 U 8 U 7 U 6 U 5 IS 4 IS	<u> </u>	2021-12-06	200
11 U 10 U 9 U 8 U 7 U 6 U 5 Is 4 Is	JPDATED AS PER TERRACE/LOT 1 UNITS		CJO
10 U 9 U 8 U 7 U 6 U 5 IS 4 IS		2021-11-05	CJO
9 U 8 U 7 U 6 U 5 IS 4 IS	JPDATED AS PER CLIENT COMMENTS	2021-10-12	CJO
8 U 7 U 6 U 5 IS 4 IS	JPDATED AS PER CLIENT COMMENTS	2021-10-06	CJO
7 U 6 U 5 IS 4 IS	JPDATED AS PER CLIENT COMMENTS	2021-09-30	CJO
6 U 5 IS 4 IS	JPDATED AS PER MUNICIPAL COMMENTS	2021-09-28	CJO
5 18 4 18	JPDATED AS PER CLIENT COMMENTS	2021-09-16	CJO
4 18	JPDATED PER MUNICIPAL REVIEW	2021-09-15	CJO
	SSUED FOR MUNICIPAL REVIEW	2021-06-11	CJO
3 15	SSUED FOR CLIENT REVIEW	2021-06-08	CJO
	SSUED FOR CLIENT REVIEW	2021-06-07	CJO
2 18	SSUED FOR CLIENT REVIEW	2021-05-27	CJO
1 15	SSUED FOR CLIENT REVIEW	2021-04-27	CJO
#			BY
	DESCRIPTION	DATE	
ION			1-3
OLLIN	DESCRIPTION SITE PLAN -		<u>1-3</u>


	LOT 13 A	REA		
Number	Comments	Area	%	
Lot 13	1 HARDSCAPE	21.36 m ²	7.74%	
Lot 13	2 SOFTSCAPE	155.60 m ²	56.37%	
Lot 13	3 LOT COVERAGE	99.08 m²	35.89%	
LOT 14 AREA				
Number	Comments	Area	%	
Lot 14	1 HARDSCAPE	22.67 m ²	13.33%	
Lot 14	2 SOFTSCAPE	60.93 m ²	35.83%	
Lot 14	3 LOT COVERAGE	86.45 m ²	50.84%	
	LOT 15 A	REA		
Number	Comments	Area	%	
Lot 15	1 HARDSCAPE	23.83 m²	13.99%	
Lot 15	2 SOFTSCAPE	59.95 m²	35.19%	
Lot 15	3 LOT COVERAGE	86.57 m²	50.82%	
LOT 16 AREA				
Number	Comments	Area	%	
Lot 16	1 HARDSCAPE	23.80 m ²	13.96%	
Lot 16	2 SOFTSCAPE	60.12 m ²	35.25%	
Lot 16	3 LOT COVERAGE	86.63 m²	50.79%	
LOT 17 AREA				
Number	Comments	Area	%	
Lot 17	1 HARDSCAPE	21.68 m ²	12.69%	
Lot 17	2 SOFTSCAPE	62.66 m²	36.69%	
Lot 17	3 LOT COVERAGE	86.45 m²	50.62%	
	LOT 18 A	REA		
Number	Comments	Area	%	
Lot 18	1 HARDSCAPE	21.38 m ²	7.68%	
		157.95 m ²	56.74%	
Lot 18	2 SOFTSCAPE	107.3011	50.7470	

Lot 18	3 LOT COVE	RAGE	99.03	m²
SSUE) FOR (SPA		

		SILEP	LAN - BLOCKS 1-3
THE UNDERSIGNED HAS REVIEWED AND TAKES RESPONSIBILITY FOR THIS DESIGN AND HAS THE QUALIFICATIONS AND MEETS THE REQUIREMENTS SET OUT IN THE ONTARIO BUILDING CODE TO BE A DESIGNER. QUALIFICATION INFORMATION		HILL RIDGE HOMES (2020-14) 일	Page Number
CAMERON ONEILL 117562	Scale	CRANBERRY MARSH ESTATES, COLLINGWOOD, ONT.	
AST	E NAME.rvt	(REV 29- 2024.03.22)	37-2
2LS DESIGN INC. 116815		T 647.456.2828 // www.2LSdesign.ca // cameron@2LSdesign.ca	

EXTERIOR ELEMENTS	MANUFACTURER	COLLECTION	COLOUR
HORIZONTAL SIDING	JAMES HARDIE	SELECT CEDARMILI	EVENING BLUE
WINDOW & DOOR TRIM	JAMES HARDIE	SELECT CEDARMILL	ARCTIC WHITE
BOARD & BATTEN SIDING	JAMES HARDIE	VERTICAL SIDING - SELECT CEDARMILL	EVENING BLUE
PANEL SIDING	JAMES HARDIE	PANEL SIDING - STATEMENT COLLECTION	ARCTIC WHITE
MASONRY	ARRISCRAFT	CITADEL	TRADITIONAL GREY
SHINGLE	IKO	CAMBRIDGE	DUAL BLACK
SOFFIT / FRIEZE / ALUM.	GENTEK	-	BLACK
FRONT DOOR	SHERWIN WILLIAMS	-	Sea Serpent SW7615
GARAGE DOOR	SHERWIN WILLIAMS	-	Sea Serpent SW7615
WINDOWS	TBD	VINYL	BLACK
RAILINGS	TBD	IRON PICKETS	BLACK



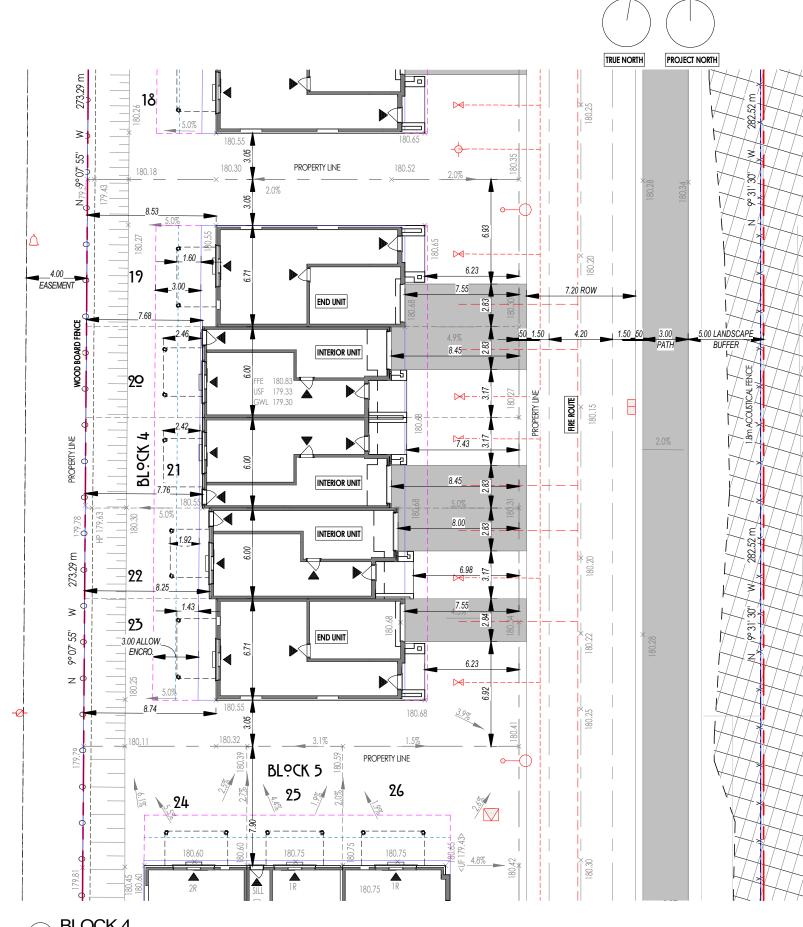

1 BLOCK 4 1 : 250


BLOCK 4 - AREA & COVERAGE				LOT 19 A	REA		
Lot #	Area	LAND USE (%)	Number	Comments	Area	%	
	157 (7 2	10 500	Lot 19	1 HARDSCAPE	21.38 m ²	7.66%	
BLOCK 4 (BLDG. AREA) BLOCK 4 - LOT 19 YARD	457.67 m ²	42.53% 16.72%	Lot 19	2 SOFTSCAPE	158.54 m ²	56.84%	
BLOCK 4 - LOT 19 TARD	85.42 m ²	7.94%					
BLOCK 4 - LOT 21 YARD	85.61 m ²	7.95%	_ Lot 19	3 LOT COVERAGE	99.03 m ²	35.50%	
BLOCK 4 - LOT 22 YARD	85.92 m ²	7.98%					
BLOCK 4 - LOT 23 YARD	181.69 m ²	16.88%	LOT 20 AREA				
	1076.23 m ²	100.00%		1			
			Number	Comments	Area	%	
BLOCK 4	- OPEN LAND	SCAPE AREA	Lot 20				
Turco	Aroc		Lot 20	2 SOFTSCAPE	61.17 m ²	35.59%	
Туре	Area	LAND USE (%)	Lot 20	3 LOT COVERAGE	86.48 m ²	50.31%	
1 HARDSCAPE	114.13 m ²	10.60%					
2 SOFTSCAPE	504.43 m ²	46.87%		LOT 21 AREA			
3 LOT COVERAGE	457.67 m ²	42.53%		-			
	1076.23 m ²	100.00%	Number	Comments	Area	%	
			Number		Area	/*	
BLOCK 4 - L			Lot 21	1 HARDSCAPE	24.25 m ²	14.10%	
BLOCK 4 - L	OT AREA		Lot 21 Lot 21	1 HARDSCAPE 2 SOFTSCAPE	24.25 m ² 61.36 m ²	14.10% 35.67%	
			Lot 21	1 HARDSCAPE	24.25 m ²	% 14.10% 35.67% 50.24%	
BLOCK 4 - L	OT AREA		Lot 21 Lot 21	1 HARDSCAPE 2 SOFTSCAPE 3 LOT COVERAGE	24.25 m ² 61.36 m ² 86.42 m ²	14.10% 35.67%	
BLOCK 4 - L	OT AREA		Lot 21 Lot 21	1 HARDSCAPE 2 SOFTSCAPE	24.25 m ² 61.36 m ² 86.42 m ²	14.10% 35.67%	
BLOCK 4 - L Lot #	OT AREA Area 278.95 m²		Lot 21 Lot 21 Lot 21	1 HARDSCAPE 2 SOFTSCAPE 3 LOT COVERAGE LOT 22 A	24.25 m ² 61.36 m ² 86.42 m ² REA	14.10% 35.67% 50.24%	
BLOCK 4 - L Lot # Lot 19 Lot 20 Lot 21 Lot 22	OT AREA Area 278.95 m ² 171.90 m ²		Lot 21 Lot 21	1 HARDSCAPE 2 SOFTSCAPE 3 LOT COVERAGE	24.25 m ² 61.36 m ² 86.42 m ²	14.10% 35.67% 50.24%	
BLOCK 4 - L Lot # Lot 19 Lot 20 Lot 21	OT AREA Area 278.95 m ² 171.90 m ² 172.03 m ² 172.40 m ² 280.94 m ²		Lot 21 Lot 21 Lot 21	1 HARDSCAPE 2 SOFTSCAPE 3 LOT COVERAGE LOT 22 A	24.25 m ² 61.36 m ² 86.42 m ² REA	14.10% 35.67% 50.24%	
BLOCK 4 - L Lot # Lot 19 Lot 20 Lot 21 Lot 22	OT AREA Area 278.95 m ² 171.90 m ² 172.03 m ² 172.40 m ²		Lot 21 Lot 21 Lot 21 Number	1 HARDSCAPE 2 SOFTSCAPE 3 LOT COVERAGE LOT 22 A Comments	24.25 m ² 61.36 m ² 86.42 m ² REA Area	14.10% 35.67%	
BLOCK 4 - L Lot # Lot 19 Lot 20 Lot 21 Lot 22	OT AREA Area 278.95 m ² 171.90 m ² 172.03 m ² 172.40 m ² 280.94 m ²		Lot 21 Lot 21 Lot 21 Number Lot 22	1 HARDSCAPE 2 SOFTSCAPE 3 LOT COVERAGE LOT 22 A Comments 1 HARDSCAPE 2 SOFTSCAPE	24.25 m ² 61.36 m ² 86.42 m ² REA Area 22.96 m ² 62.96 m ²	14.10% 35.67% 50.24% 13.32% 36.52%	
BLOCK 4 - L Lot # Lot 19 Lot 20 Lot 21 Lot 22	OT AREA Area 278.95 m ² 171.90 m ² 172.03 m ² 172.40 m ² 280.94 m ²		Lot 21 Lot 21 Lot 21 Number Lot 22 Lot 22	1 HARDSCAPE 2 SOFTSCAPE 3 LOT COVERAGE LOT 22 A Comments 1 HARDSCAPE 2 SOFTSCAPE 3 LOT COVERAGE	24.25 m ² 61.36 m ² 86.42 m ² REA Area 22.96 m ² 62.96 m ² 86.48 m ²	14.10% 35.67% 50.24%	
BLOCK 4 - L Lot # Lot 19 Lot 20 Lot 21 Lot 22	OT AREA Area 278.95 m ² 171.90 m ² 172.03 m ² 172.40 m ² 280.94 m ²		Lot 21 Lot 21 Lot 21 Number Lot 22 Lot 22	1 HARDSCAPE 2 SOFTSCAPE 3 LOT COVERAGE LOT 22 A Comments 1 HARDSCAPE 2 SOFTSCAPE	24.25 m ² 61.36 m ² 86.42 m ² REA Area 22.96 m ² 62.96 m ² 86.48 m ²	14.10% 35.67% 50.24% 13.32% 36.52%	
BLOCK 4 - L Lot # Lot 19 Lot 20 Lot 21 Lot 22	OT AREA Area 278.95 m ² 171.90 m ² 172.03 m ² 172.40 m ² 280.94 m ²		Lot 21 Lot 21 Lot 21 Number Lot 22 Lot 22	1 HARDSCAPE 2 SOFTSCAPE 3 LOT COVERAGE LOT 22 A Comments 1 HARDSCAPE 2 SOFTSCAPE 3 LOT COVERAGE	24.25 m ² 61.36 m ² 86.42 m ² REA Area 22.96 m ² 62.96 m ² 86.48 m ²	14.10% 35.67% 50.24% 13.32% 36.52% 50.16%	
BLOCK 4 - L Lot # Lot 19 Lot 20 Lot 21 Lot 22	OT AREA Area 278.95 m ² 171.90 m ² 172.03 m ² 172.40 m ² 280.94 m ²		Lot 21 Lot 21 Lot 21 Lot 21 Lot 22 Lot 22 Lot 22	1 HARDSCAPE 2 SOFTSCAPE 3 LOT COVERAGE LOT 22 A Comments 1 HARDSCAPE 2 SOFTSCAPE 3 LOT COVERAGE LOT 23 A	24.25 m ² 61.36 m ² 86.42 m ² REA Area 22.96 m ² 62.96 m ² 86.48 m ² REA	14.10% 35.67% 50.24% 13.32% 36.52% 50.16%	
BLOCK 4 - L Lot # Lot 19 Lot 20 Lot 21 Lot 22	OT AREA Area 278.95 m ² 171.90 m ² 172.03 m ² 172.40 m ² 280.94 m ²		Lot 21 Lot 21 Lot 21 Lot 21 Lot 22 Lot 22 Lot 22 Lot 22	1 HARDSCAPE 2 SOFTSCAPE 3 LOT COVERAGE LOT 22 A Comments 1 HARDSCAPE 2 SOFTSCAPE 3 LOT COVERAGE LOT 23 A Comments	24.25 m ² 61.36 m ² 86.42 m ² REA Area 22.96 m ² 62.96 m ² 86.48 m ² REA Area	14.10% 35.67% 50.24% 13.32% 36.52% 50.16%	

BY LAW - 2010-040 -- BLOCK 4

	ZONING MATRIX		
	4.0 GENERAL PROVISIONS	REQUIRED	PROVIDED
4.16.2	SIGHT TRIANGLES (min)	6.0m	n/a
TABLE 4.27.3.1	INCREASED YARDS ABUTTING ROADS ALONG HWY 26 WEST	40.0m ROW 20.0m CL SETBACK	n/a
4.28.4	ARCHITECTURAL ELEMENTS (max) UNENCLOSED PORCH/STEPS (max) UNENCLOSED PORCH IN A REAR YARD (max)	0.6m (any yard) 1.5m, but not closer than 1.2m 3.0m	n/a n/a 1.43m-2.46m
	SECTION 5.0 PARKING & LOADING PROVISION	<u>NS</u>	
5.3.1.1.	whichever is less	6.5m -or- 50% lot frontage	2.83m
TABLE 5.8.11 5.6.2. 5.3.1.2.	NUMBER OF PARKING SPACES PARKING SPACES SIZE DRIVEWAY WDITH (max) ENTRANCE ROAD WIDTH (min) ENTRANCE SETBACK (min)	2/UNIT 2.8m x 6.0m 50% of yard for driveway 7.5m 15.0m	2 2.8m x 6.0m 2.83m 8.2m n/a
	SECTION 6.0 RESIDENTIAL ZONES		
<u>(H10) R3-34</u>	PERMITTED USE	TOWNHOUSE	<u>(H10) R3-34</u>
6.5 (R3-34) 6.5 (R3-34) TABLE 6.3.1.2 6.5 (R3-34) TABLE 6.3.1.2 TABLE 6.3.1.2 TABLE 6.3.1.2 TABLE 6.3.1.2	LOT AREA (min.) LOT FRONTAGE (min) FRONT YARD (min) REAR YARD (min) INT. SIDE YARD (min) EXT. SIDE YARD (min) LOT COVEREAGE (max) LANDSCAPE OPEN SPACE(min) HEIGHT (max) EASTERN PROPERTY LANDSCAPE STRIP	140m²/UNIT 6.0m 7.5m 7.5m 3.0m 4.5m 45% 35% 12.0m 5.0m	171.90m ² - 280.94m ² 6.0m - 9.76m 7.55m - 8.45m 7.68m - 8.53m 3.05m n/a 35.58% - 50.84% 35.59% - 57.09% 11.96m (estimated) 5.0m
	SECTION 9.0 ENVIRONMENTAL ZONES		
TABLE 9.3.1.1. TABLE 9.3.1.1.	FRONT YARD (min) EXT. SIDE YARD (min) INT. SIDE YARD (min) REAR YARD (min) LOT COVEREAGE (max) LANDSCAPE OPEN SPACE(min)	nil nil 3.0m 3.0m 3.0m 10% 80% 12.0m WALKING TRAILS PRIVATE ROAD	nii nii nii nii nii nii nii nii nii
		CONSERVATION PRIVATE RECREATIONAL	

COLOUR SCHEDULE - BLOCK 5			
EXTERIOR ELEMENTS	MANUFACTURER	COLLECTION	COLOUR
HORIZONTAL SIDING WINDOW & DOOR TRIM BOARD & BATTEN SIDING PANEL SIDING MASONRY SHINGLE FRIEZE / ALUM. SOFFIT FRONT DOOR GARAGE DOOR WINDOWS RAILINGS	JAVES HARDIE JAVES HARDIE JAVES HARDIE JAVES HARDIE JAVES HARDIE ARRISCRAFT IKO GENTEK - SHERWIN WILLIAWS SHERWIN WILLIAWS TBD TBD	SELECT CEDARMILL SELECT CEDARMIL VERTICAL SIDING - SELECT CEDARMILL PANEL SIDING - STATEMENT COLLECTION FRESCO CAMBRIDGE - - - - VINYL IRON PICKETS	IRON GRAY IRON GRAY IRON GRAY IRON GRAY SILVERADO DUAL BLACK BLACK CEDAR Tricorn Black SW6258 BLACK BLACK



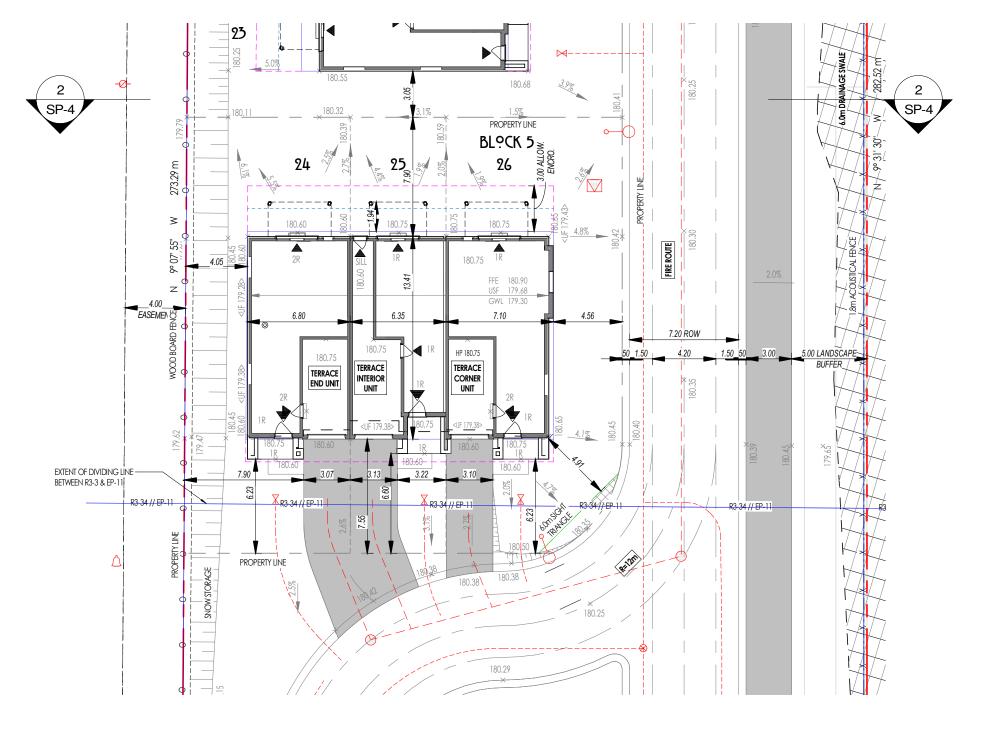

2 BLOCK 5 1 : 250

B	LOCK 5 - AF	REA & COVE	ERAGE		LOT 24 A	REA
Lot #		Area	Area LAND USE (%)		Comments	Area
		308.95 m ²	41.78%	Lot 24	1 HARDSCAPE	13.33 m ²
OCK 5 (BLDG. AREA)		308.95 m ² 173.15 m ²	23.42%	Lot 24	2 SOFTSCAPE	159.82 m ²
DCK 5 - LOT 24 TARD		66.09 m ²	8.94%			
CK 5 - LOT 26 YARD		191.22 m ²	25.86%	Lot 24	3 LOT COVERAGE	105.75 m ²
BI OCK I					LOT 25 A	REA
DLOOK				Number	Comments	Area
Туре	Arec	a L	AND USE (%)	Lot 25	1 HARDSCAPE	13.58 m ²
	40.15	E 107		Lot 25	2 SOFTSCAPE	52.51 m ²
HARDSCAPE SOFTSCAPE	40.15 m ² 390.32 m ²	5.43% 52.79%		Lot 25	3 LOT COVERAGE	96.95 m ²
OT COVERAGE	308.95 m ²	41.78%				
	739.41 m ²	100.00%			LOT 26 A	REA
BLOCK 5 -	LOT AREA			Number	Comments	Area
Lot #	Arec			Lot 26	1 HARDSCAPE	13.24 m ²
LUI #	Arec			Lot 26	2 SOFTSCAPE	177.99 m ²
† 24	278.90 m ²			Lot 26	3 LOT COVERAGE	106.25 m ²
25	163.04 m ²					
26	297.48 m ²					
20						

BY LAW - 2010-040 BLOCK 5		
ZONING MATRIX		
4.0 GENERAL PROVISIONS	REQUIRED	PROVIDED
SIGHT TRIANGLES (min)	6.0m	6.0m
INCREASED YARDS ABUTTING ROADS ALONG HWY 26 WEST	40.0m ROW 20.0m CL SETBACK	n/a
UNENCLOSED PORCH/STEPS (max)	0.6m (any yard) 1.5m, but not closer than 1.2m 3.0m	n/a n/a 1.94m
SECTION 5.0 PARKING & LOADING PROVISION	<u>2v</u>	
whichever is less NUMBER OF PARKING SPACES PARKING SPACES SIZE DRIVEWAY WIDTH (mox) ENTRANCE ROAD WIDTH (min)	6.5m -or- 50% lot frontage 2/UNIT 2.8m x 6.0m 50% of yard for driveway 7.5m 15.0m	3.07m - 3.13m 2 2.8m x 6.0m 3.07m - 3.13m 8.2m n/a
SECTION 6.0 RESIDENTIAL ZONES		
PERMITTED USE	TOWNHOUSE	<u>(H10) R3-34</u>
LOT FRONTAGE (min) FRONT YARD (min) REAR YARD (min) INT. SIDE YARD (min) EXT. SIDE YARD (min) LOT COVEREAGE (max) LANDSCAPE OPEN SPACE(min) HEIGHT (max)	140m²/UNIT 6.0m 7.5m 7.5m 3.0m 4.5m 45% 35% 12.0m 5.0m	163.04m² - 297.48m² 6.35m - 11.66m 7.55m 7.90m 4.05m n/a 35.72% - 59.46% 32.21% - 59.83% 12.00m 5.0m
SECTION 9.0 ENVIRONMENTAL ZONES		
LOT FRONTAGE (min) FRONT YARD (min) EXT. SIDE YARD (min) INT. SIDE YARD (min) REAR YARD (min) LOT COVEREAGE (max) LANDSCAPE OPEN SPACE(min) HEIGHT (max)	nil nil 3.0m 3.0m 3.0m 3.0m 10% 80% 12.0m WALKING TRAILS PRIVATE ROAD	nil nil nil nil nil nil nil nil nil
	ZONING MATRIX AGENERAL PROVISIONS SIGHT TRIANGLES (min) INCREASED YARDS ABUTTING ROADS ALONG HWY 26 WEST ARCHITECTURAL ELEMENTS (max) UNENCLOSED PORCH IN A REAR YARD (max) UNENCLOSED PORCH IN A REAR YARD (max) SECTION 5.0 PARKING & LOADING PROVISION ENTRANCE WIDTH (max) whichever is less NUMBER OF PARKING SPACES PARKING SPACES SIZE DRIVEWY WIDTH (max) ENTRANCE ROAD WIDTH (min) ENTRANCE SETBACK (min) SECTION 5.0 RESIDENTIAL ZONES PERWITTED USE LOT AREA (min.) LOT FRONTAGE (min) REAR YARD (min) INT. SIDE YARD (min) EXT. SIDE YARD (min) HEIGHT (max) EASTERN PROPERTY LANDSCAPE STRIP SECTION 9.0 ENVIRONMENTAL ZONES LOT AREA (min.) LOT FRONTAGE (min) REAR YARD (min) INT. SIDE YARD (min) HEIGHT (max) EXT. SIDE YARD (min) INT. SIDE YARD (min) INT. SIDE YARD (min) INT. SIDE YARD (min) REAR YARD (min) INT. SIDE YARD (min) INT. SIDE YARD (min) INT. SIDE YARD (min) EXT. SIDE YARD (min) REAR YARD (min) INT. SIDE YARD (min) REAR YARD (min) INT. SIDE YARD (min) REAR YARD (min) INT. SIDE YARD (min) INT. SID	ZONING MATRIXREQUIREDAL CENERAL PROVISIONSREQUIREDSIGHT TRIANGLES (min)6.0mINCREASED YARDS ABUTTING ROADS ALONG HWY 26 WEST40.0m ROW 20.0m CL SETBACKARCHTECTURAL ELEMENTS (mox)0.6m (any yard) 1.5m, but not closer than 1.2m 20.0m CL SETBACKMINENCLOSED PORCH/SITEPS (mox)1.5m, but not closer than 1.2m 20.0m CL SETBACKMUNENCLOSED PORCH/SITEPS (mox)1.5m, but not closer than 1.2m 20.0m CL SETBACKMUNENCLOSED PORCH/SITEPS (mox)3.0mENTRANCE WIDTH(mox)6.5m -or- 20.0m Kichever is less 20.0m Kichever is less <br< th=""></br<>

		31 -	-	-
		30 -	-	-
		29 ISSUED FOR SITE PLAN APPROVAL	2024-03-22	CJO
		28 ISSUED FOR SITE PLAN APPROVAL	2023-12-05	CJO
		27 REV. AS PER MUNICIPAL COMMENTS	2023-10-17	CJO
		26 REV. AS PER MUNICIPAL COMMENTS	2023-07-28	CJO
		25 ISSUED FOR CLIENT REVIEW	2023-05-24	CJO
		24 ISSUED FOR CLIENT REVIEW	2023-04-21	CJO
		23 ISSUED FOR SITE PLAN APPROVAL	2022-12-05	CJO
		22 REV. AS PER CIVIL ENG. COMMENTS	2022-11-25	CJO
		21 REV. AS PER MUNICIPAL COMMENTS	2022-11-18	CJO
		20 REVISED AS PER MUNICIPAL COMMENTS	2022-10-21	
		19 REVISED AS PER MUNICIPAL COMMENTS	2022-09-19	CJO
		18 ISSUED FOR SITE PLAN APPROVAL	2022-03-04	
		17 ISSUED FOR CLIENT REVIEW	2022-03-02	
		16 ISSUED FOR CLIENT REVIEW	2022-02-17	
		15 ISSUED FOR CLIENT REVIEW	2022-02-13	
		14 UPDATED AS PER CLIENT COMMENTS	2021-12-22	
		13 REV. AS PER LOT 24 SIDEYARD @ 4.0m	2021-12-06	
		12 UPDATED AS PER TERRACE/LOT 1 UNITS	2021-11-05	
		11 UPDATED AS PER CLIENT COMMENTS	2021-10-12	
		10 UPDATED AS PER CLIENT COMMENTS	2021-10-06	
		9 UPDATED AS PER CLIENT COMMENTS	2021-09-30	
		8 UPDATED AS PER MUNICIPAL COMMENTS	2021-09-28	
		7 UPDATED AS PER CLIENT COMMENTS	2021-09-16	
		6 UPDATED PER MUNICIPAL REVIEW	2021-09-15	
		5 ISSUED FOR MUNICIPAL REVIEW	2021-06-11	
		4 ISSUED FOR CLIENT REVIEW	2021-06-08	
		3 ISSUED FOR CEIENT REVIEW	2021-06-07	
		2 ISSUED FOR CLIENT REVIEW	2021-05-27	
		1 ISSUED FOR CLIENT REVIEW	2021-04-27	CJO
			DATE	
		# DESCRIPTION	DATE	BY
ISSUED FOR SPA THE UNDERSIGNED HAS REVIEWED AND TAKES RESPONSIBILITY FOR THIS DESIGN AND HAS THE QUALIFICATIONS		SITE PLAN -	BLOCKS	4-5
THE UNDERSIGNED THIS TEVIEVED AND TAKES REPORTING IT FOR THIS DESIGN AND PAST THE UDILITION ATTORS MOD WEETS THE REQUIREMENTS SET OUT IN THE ONTARIO BUILDING CODE TO BE A DESIGNER. QUALIFICATION INFORMATION	CJO CJO	HILL RIDGE HOMES (2020-14)	Page Number	
CAMERON O'NEILL 117562 NAME BCI'N NUMBER	As indicated	CRANBERRY MARSH ESTATES, COLLINGWOOD, ONT.		2
	FILE NAME.rvt	(REV 29- 2024.03.22)))
EIRM REGISTRATION INFO: 2.19 DEGININC. All drawings specifications related documents and design are the copyright		T 647.456.2828 // www.2LSdesign.ca // cameron@2LSdesign.ca [®] X		



HILL RIDGE HOMES **CRANBERRY MARSH ESTATES TOWN OF COLLINGWOOD**



KEY PLAN



INDEX

DWG NO.	DESCRIPTION
	TITLE PAGE AND INDEX
ESC-1	EROSION AND SEDIMENT CONTROL PLAN
ESC-2	EROSION AND SEDIMENT CONTROL DETAILS
SAN-1	SANITARY DRAINAGE PLAN
DP-1	PRE-DEVELOPMENT DRAINAGE PLAN
DP-2	POST-DEVELOPMENT DRAINAGE PLAN
PP-1	SITE SERVICING PLAN AND PROFILE
SG-1	SITE GRADING PLAN
DE-1	DETAILS & NOTES
E1.1	SINGLE DIAGRAM
E2.1	SITE PLAN – POWER LAYOUT
E3.1	SITE PLAN – LIGHTING LAYOUT
E3.2	LIGHTING DETAILS – SHEET 1
E3.3	LIGHTING DETAILS – SHEET 2
E4.1	SITE PLAN – PHOTOMETRICS LAYOUT


5TH SUBMISSION CONTRACT No. 120181


STOP SIGN


PROPERTY LINE	
EXISTING CENTERLINE	
PROPOSED CENTRELINE	
EXISTING EDGE OF ASPHALT	
PROPOSED EDGE OF ASPHALT	
EXISTING EDGE OF SHOULDER	
PROPOSED EDGE OF SHOULDER	
EXISTING DITCH/DIRECTION OF FLOW	·
PROPOSED DITCH/DIRECTION OF FLOW	
EXISTING SANITARY SEWER/SIZE/DIRECTION OF FLOW	
PROPOSED SANITARY SEWER/SIZE/DIRECTION OF FLOW	
EXISTING SANITARY SERVICE	
PROPOSED SANITARY SERVICE	
EXISTING SANITARY FORCEMAIN/SIZE/DIRECTION OF FLOW	<u>2000 SAN F/M</u>
EXISTING WATERMAIN/SIZE	<u>150ø W/M</u>
PROPOSED WATERMAIN/SIZE	<u>150¢ W/M</u>
EXISTING WATER SERVICE	
PROPOSED WATER SERVICE	
EXISTING STORM SEWER/SIZE/DIRECTION OF FLOW	<u>375ø</u> _ <u>STM</u>
PROPOSED STORM SEWER/SIZE/DIRECTION OF FLOW	<u>375ø STM</u>
EXISTING CULVERT	
PROPOSED SWALE LOCATION	
PROPOSED CULVERT	
PROPOSED JOINT HYDRO, BELL AND ROGERS	
EXISTING GAS MAIN	
PROPOSED GAS MAIN	
EXISITNG FENCELINE	
PROPOSED FENCELINE	
EXISTING BUSHLINE	~~~~~~~~~~~~~~~~~~~~~~~~~~~~~~~~~~~~~~~
EXISTING CONTOUR	179.00
EXISTING SPOT ELEVATION	× 179.00
PROPOSED SPOT ELEVATION	× 179.00
EXISTING GRADING DIRECTION	
PROPOSED GRADING DIRECTION	
PROPOSED SWALE LOCATION	
EXISTING TEMPORARY BENCHMARK	• TBM
EXISTING STANDARD IRON BAR	
EXISTING BOREHOLE/NUMBER	🕂 вня
EXISTING GAS VALVE	🖂 GAS
EXISTING HYDRO TRANSFORMER	Ξ
EXISTING CABLE PEDESTAL	C
EXISTING BELL PEDESTAL	B
EXISTING BELL MAINTENANCE HOLE	O BELL MH
EXISTING BELL POLE	O BP
EXISTING HYDRO POLE	O HP
EXISTING HYDRO GUY WIRE)
PROPOSED LIGHT STANDARD	•LS
EXISTING DECIDUOUS TREE	
EXISTING CONIFEROUS TREE	
EXISTING SANITARY MAINTENANCE HOLE/NUMBER	SAN MH17
PROPOSED SANITARY MAINTENANCE HOLE/NUMBER	SANMH1
EXISTING HYDRANT AND VALVE	-\$- HYD & WV
PROPOSED HYDRANT AND VALVE	✦HYD & WV
EXISTING WATER VALVE	\bowtie w
PROPOSED WATER VALVE	M WV
PROPOSED CURB STOP VALVE	► CSV
EXISTING STORM MAINTENANCE HOLE	STM MH
	0
EXISTING CATCH BASIN	
TACTILE SURFACE INDICATORS	
TRANSFORMER AND GROUNDING RODS	
SWITCHGEAR	\blacksquare
LIGHTING PEDESTAL	Щ.
STOP SIGN	SS

SS⊜


LEGEND

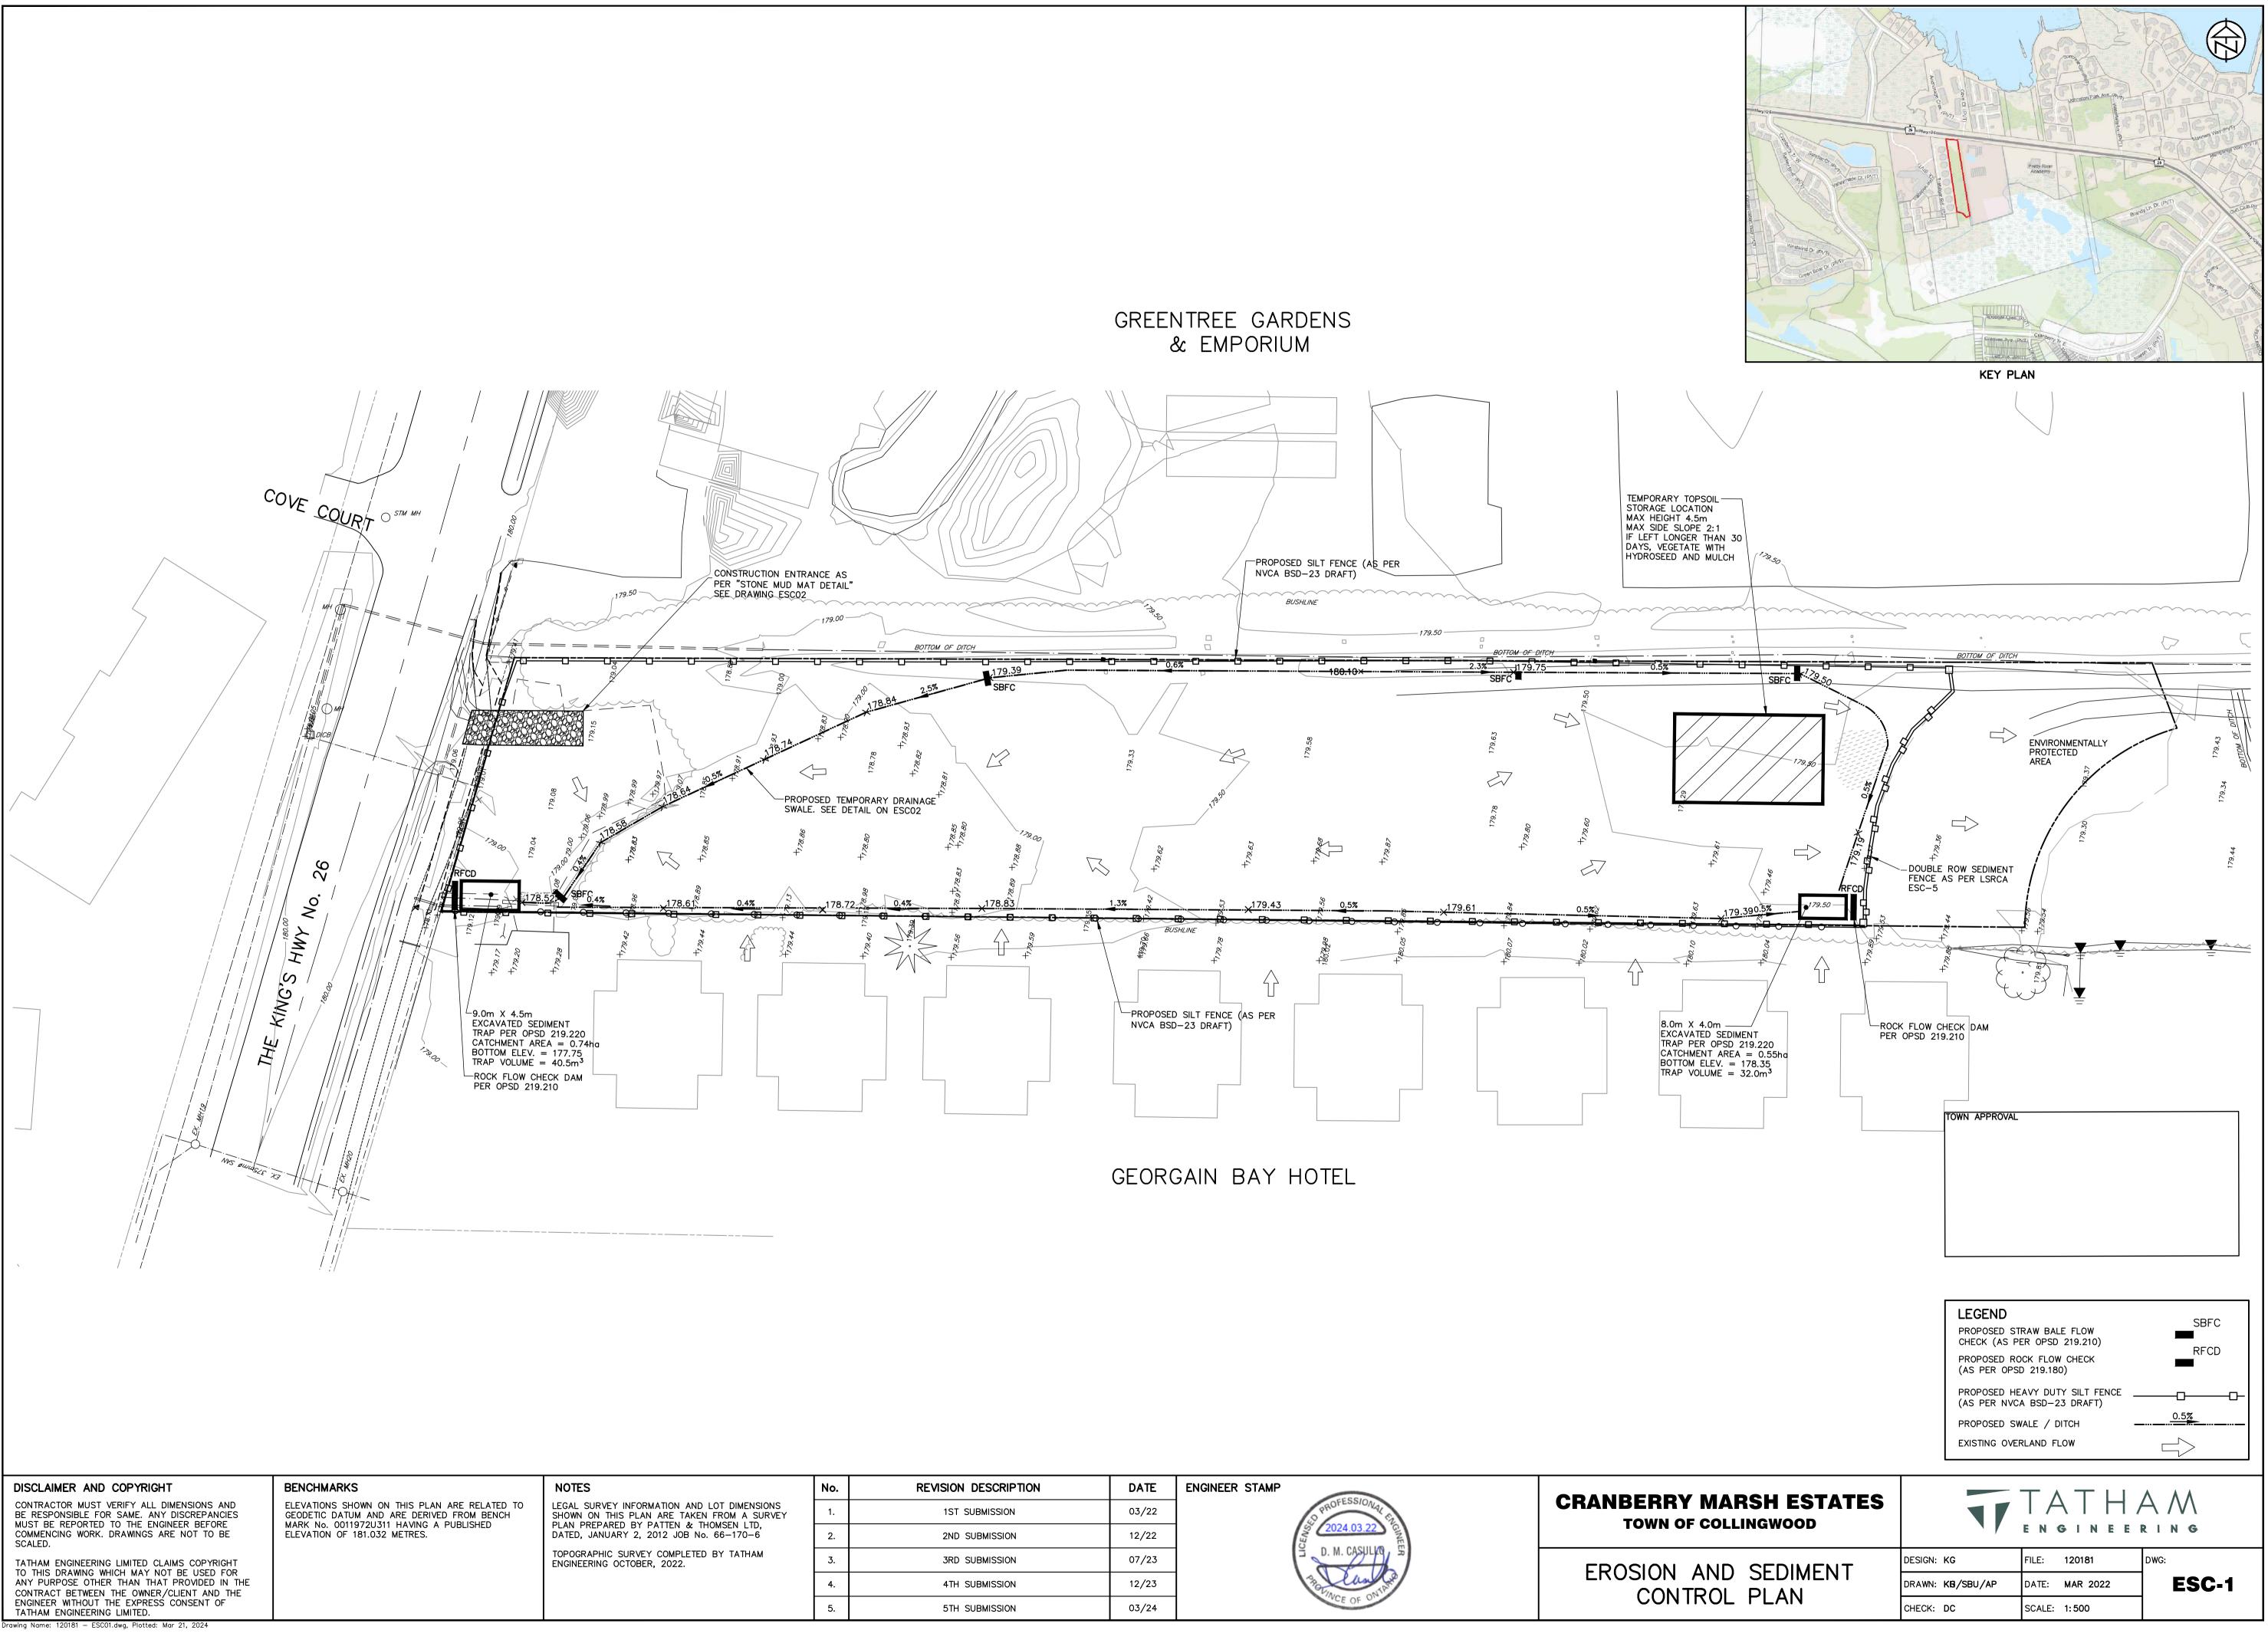


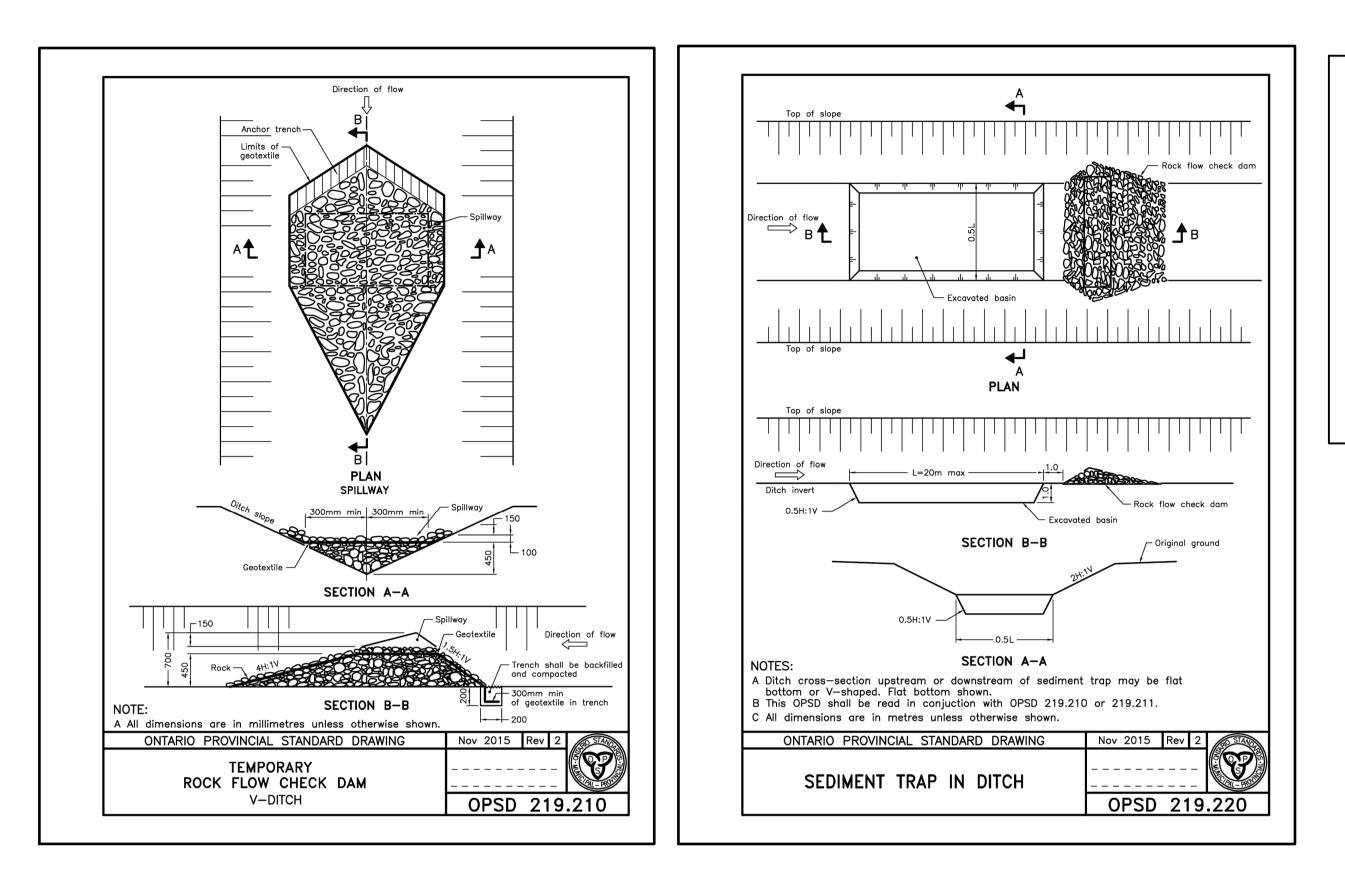

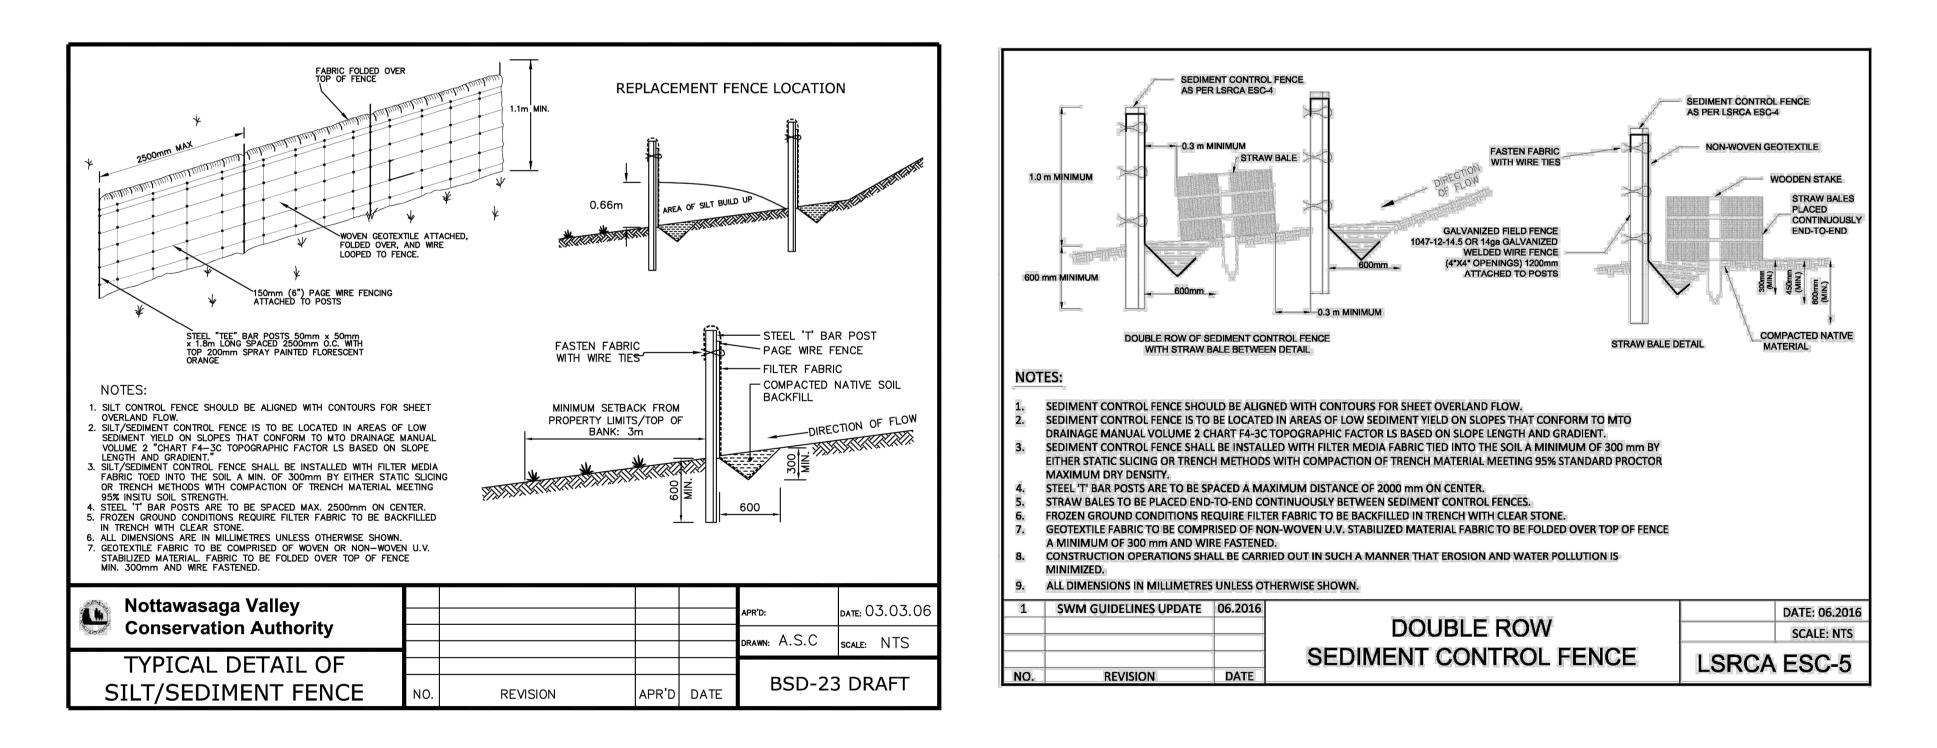


DISCLAIMER AND COPYRIGHT	BENCHMARKS	NOTES	No.	REVISION DESCRIPTION	DATE	ENGINEER STAMP	
CONTRACTOR MUST VERIFY ALL DIMENSIONS AND BE RESPONSIBLE FOR SAME. ANY DISCREPANCIES	ELEVATIONS SHOWN ON THIS PLAN ARE RELATED TO GEODETIC DATUM AND ARE DERIVED FROM BENCH	LEGAL SURVEY INFORMATION AND LOT DIMENSIONS SHOWN ON THIS PLAN ARE TAKEN FROM A SURVEY	1.	1ST SUBMISSION	03/22	LS PROFESSIONAL ST	CRANBERRY MARSH TOWN OF COLLINGW
MUST BE REPORTED TO THE ENGINEER BEFORE COMMENCING WORK. DRAWINGS ARE NOT TO BE SCALED.	MARK No. 0011972U311 HAVING A PUBLISHED ELEVATION OF 181.032 METRES.	PLAN PREPARED BY PATTEN & THOMSEN LTD, DATED, JANUARY 2, 2012 JOB No. 66-170-6	2.	2ND SUBMISSION	12/22		
TATHAM ENGINEERING LIMITED CLAIMS COPYRIGHT		TOPOGRAPHIC SURVEY COMPLETED BY TATHAM ENGINEERING OCTOBER, 2022.	3.	3RD SUBMISSION	07/23	□ D. M. CASULKO S	EROSION AND SEL CONTROL DETA
TO THIS DRAWING WHICH MAY NOT BE USED FOR ANY PURPOSE OTHER THAN THAT PROVIDED IN THE CONTRACT BETWEEN THE OWNER/CLIENT AND THE			4.	4TH SUBMISSION	12/23	33 Campbell	
ENGINEER WITHOUT THE EXPRESS CONSENT OF TATHAM ENGINEERING LIMITED.			5.	5TH SUBMISSION	03/24	NCE OF OF	
Drawing Name: 120181 — ESC01.dwg, Plotted: Mar 21, 2024							

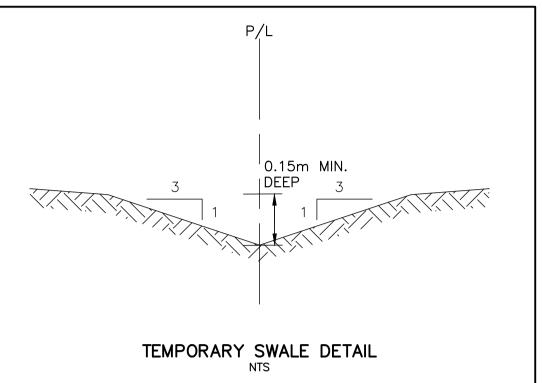

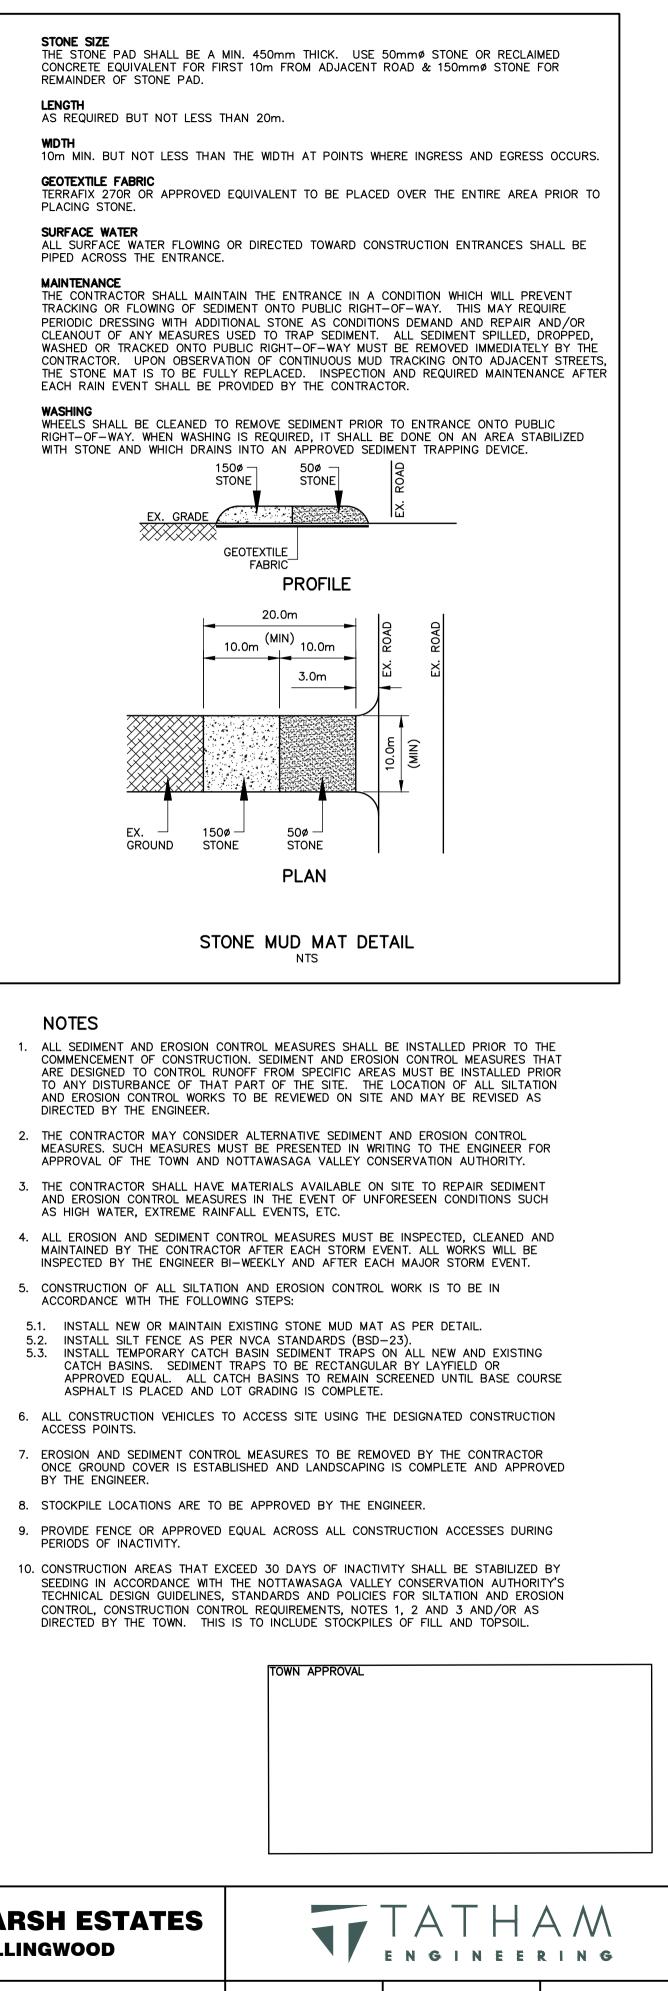



SEDIMENT	DESIGN: KG	FILE:	120181	DWG:
	DRAWN: KH/SBU/AP	DATE:	MAR 2022	ESC-2
ETAILS	CHECK: DC	SCALE:	N.T.S.	

- 2. THE CONTRACTOR MAY CONSIDER ALTERNATIVE SEDIMENT AND EROSION CONTROL
- 3. THE CONTRACTOR SHALL HAVE MATERIALS AVAILABLE ON SITE TO REPAIR SEDIMENT
- 4. ALL EROSION AND SEDIMENT CONTROL MEASURES MUST BE INSPECTED, CLEANED AND
- 5. CONSTRUCTION OF ALL SILTATION AND EROSION CONTROL WORK IS TO BE IN
- 5.1. INSTALL NEW OR MAINTAIN EXISTING STONE MUD MAT AS PER DETAIL. 5.2. INSTALL SILT FENCE AS PER NVCA STANDARDS (BSD-23). 5.3. INSTALL TEMPORARY CATCH BASIN SEDIMENT TRAPS ON ALL NEW AND EXISTING
- 6. ALL CONSTRUCTION VEHICLES TO ACCESS SITE USING THE DESIGNATED CONSTRUCTION
- 8. STOCKPILE LOCATIONS ARE TO BE APPROVED BY THE ENGINEER.
- 9. PROVIDE FENCE OR APPROVED EQUAL ACROSS ALL CONSTRUCTION ACCESSES DURING

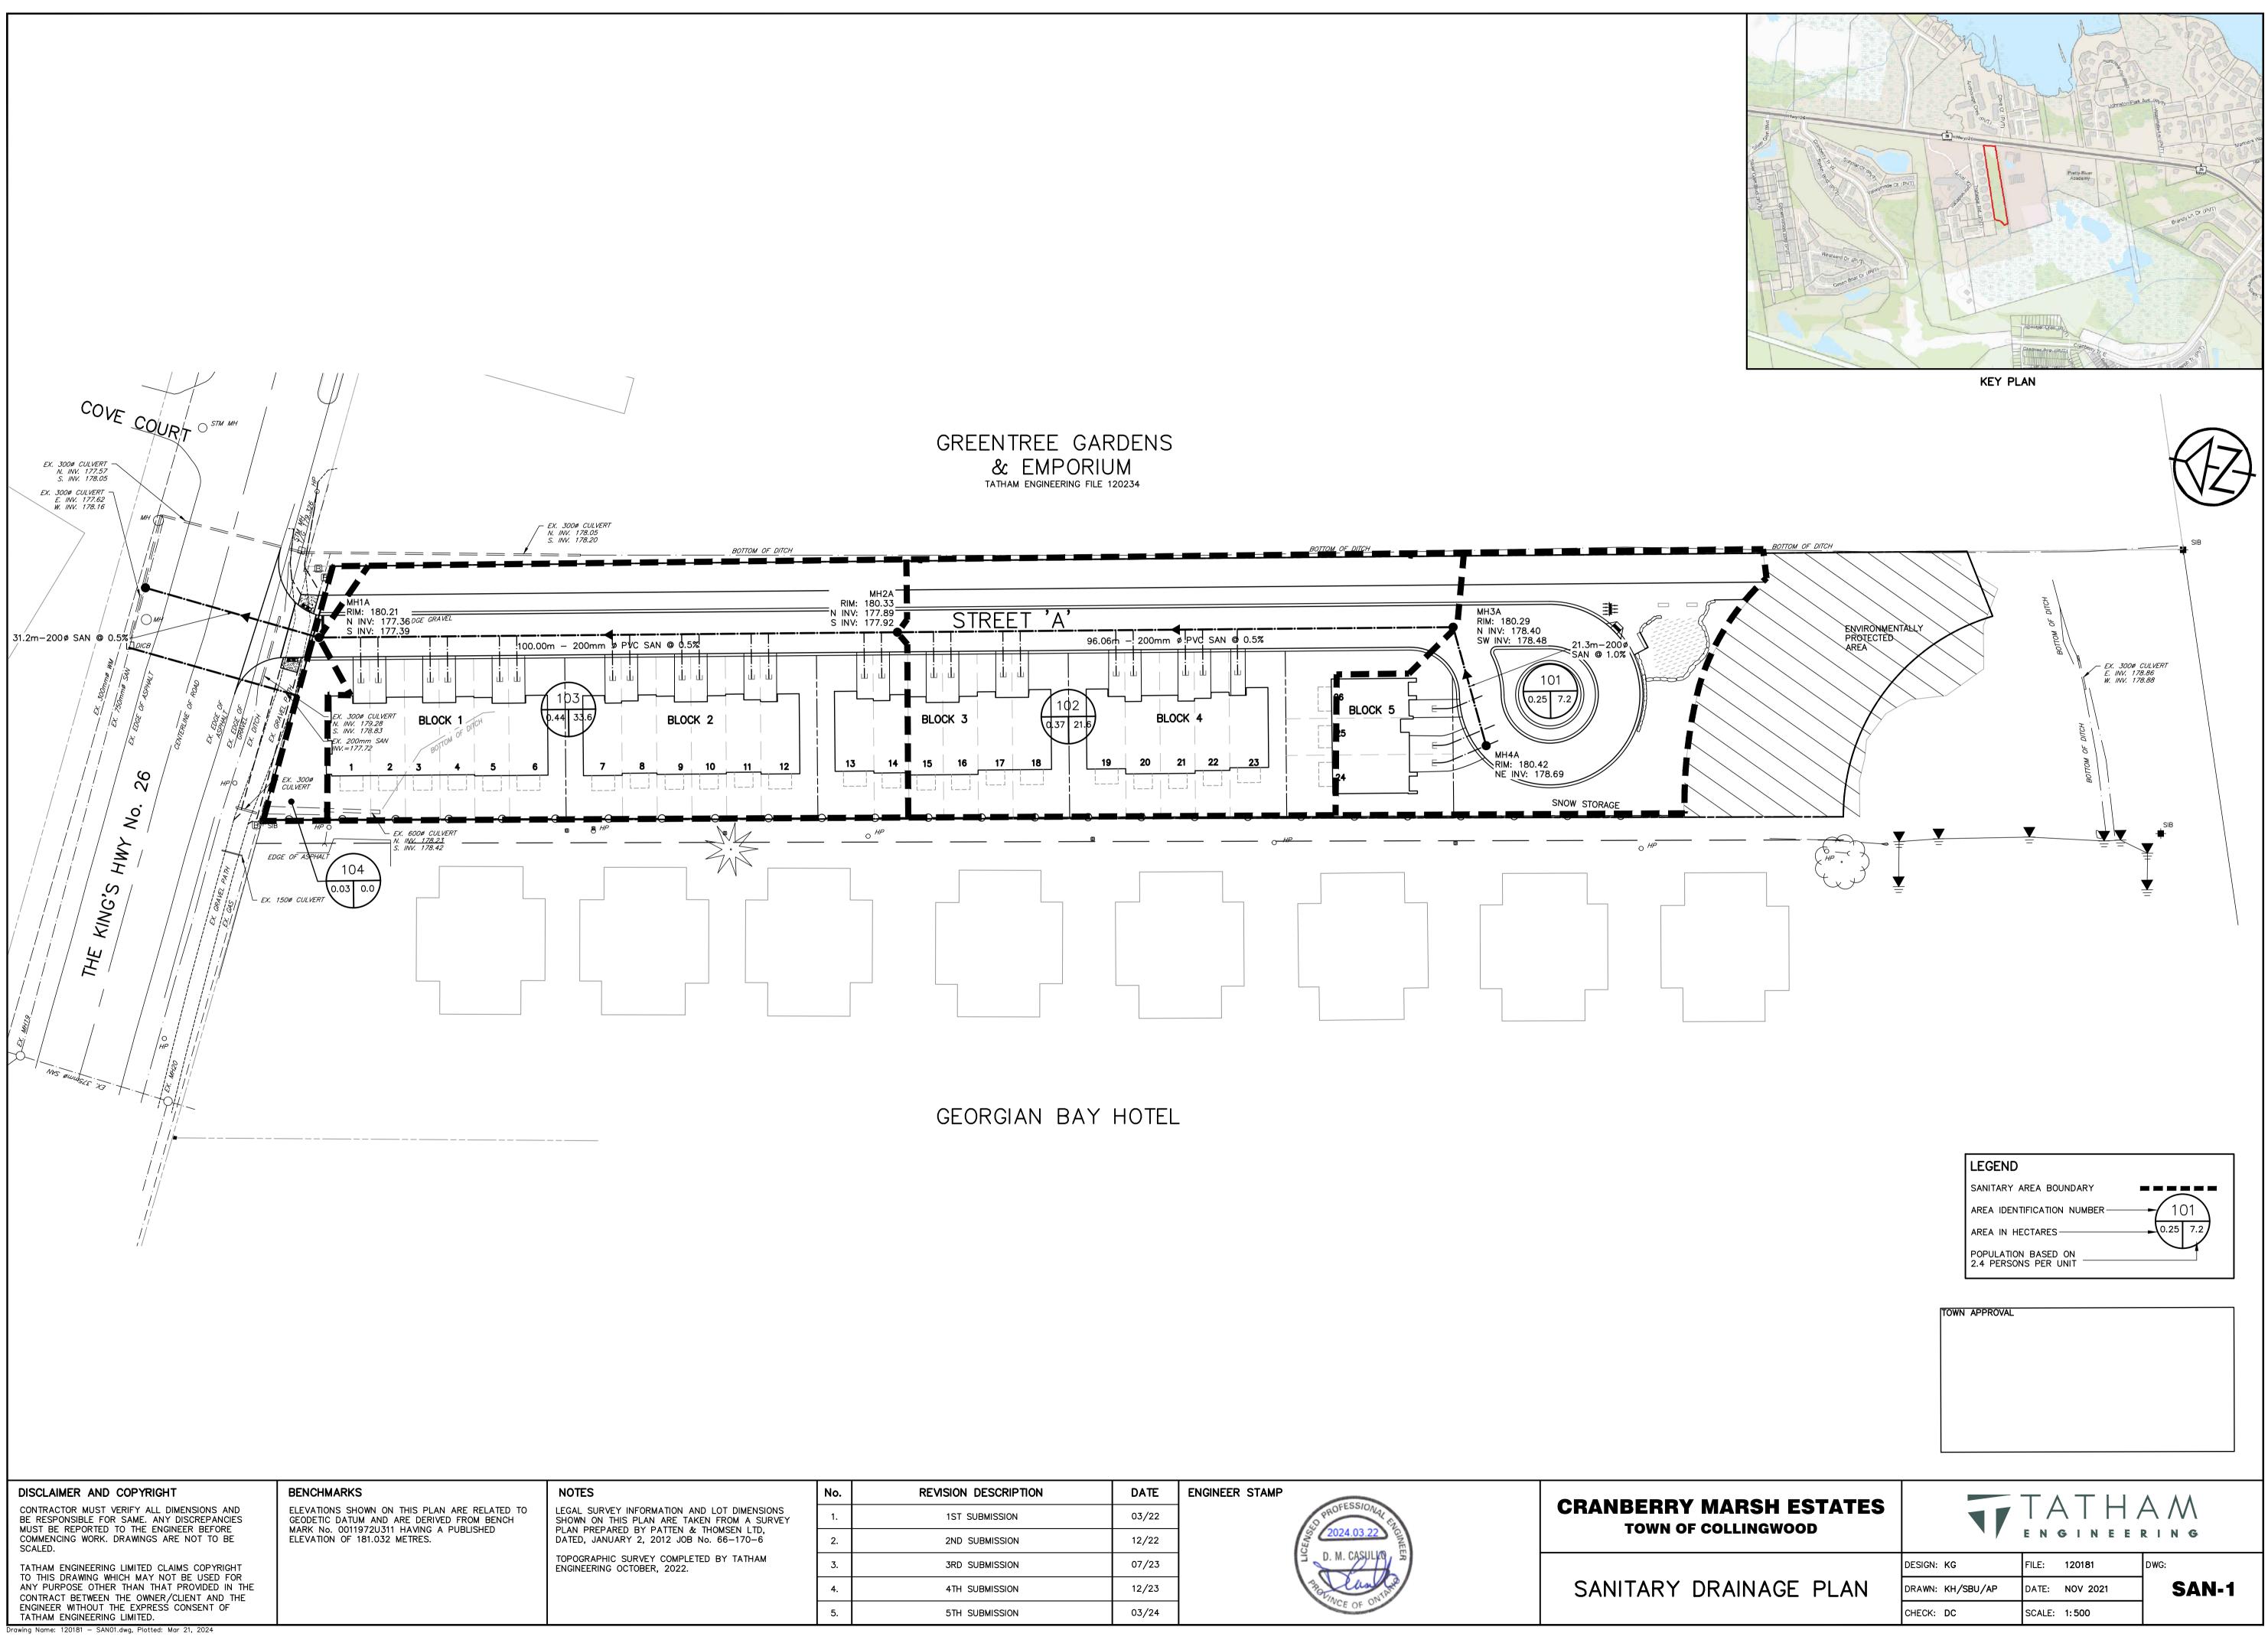



	ENGINEER STAMP	DATE	REVISION DESCRIPTION	No.
CRANBERRY MAR TOWN OF COLLI	ED PROFESSION AL	03/22	1ST SUBMISSION	1.
		12/22	2ND SUBMISSION	2.
SANITARY DRA	∃ D. M. CASULKO S	07/23	3RD SUBMISSION	3.
	3 Can to	12/23	4TH SUBMISSION	4.
	NUCE OF OU	03/24	5TH SUBMISSION	5.

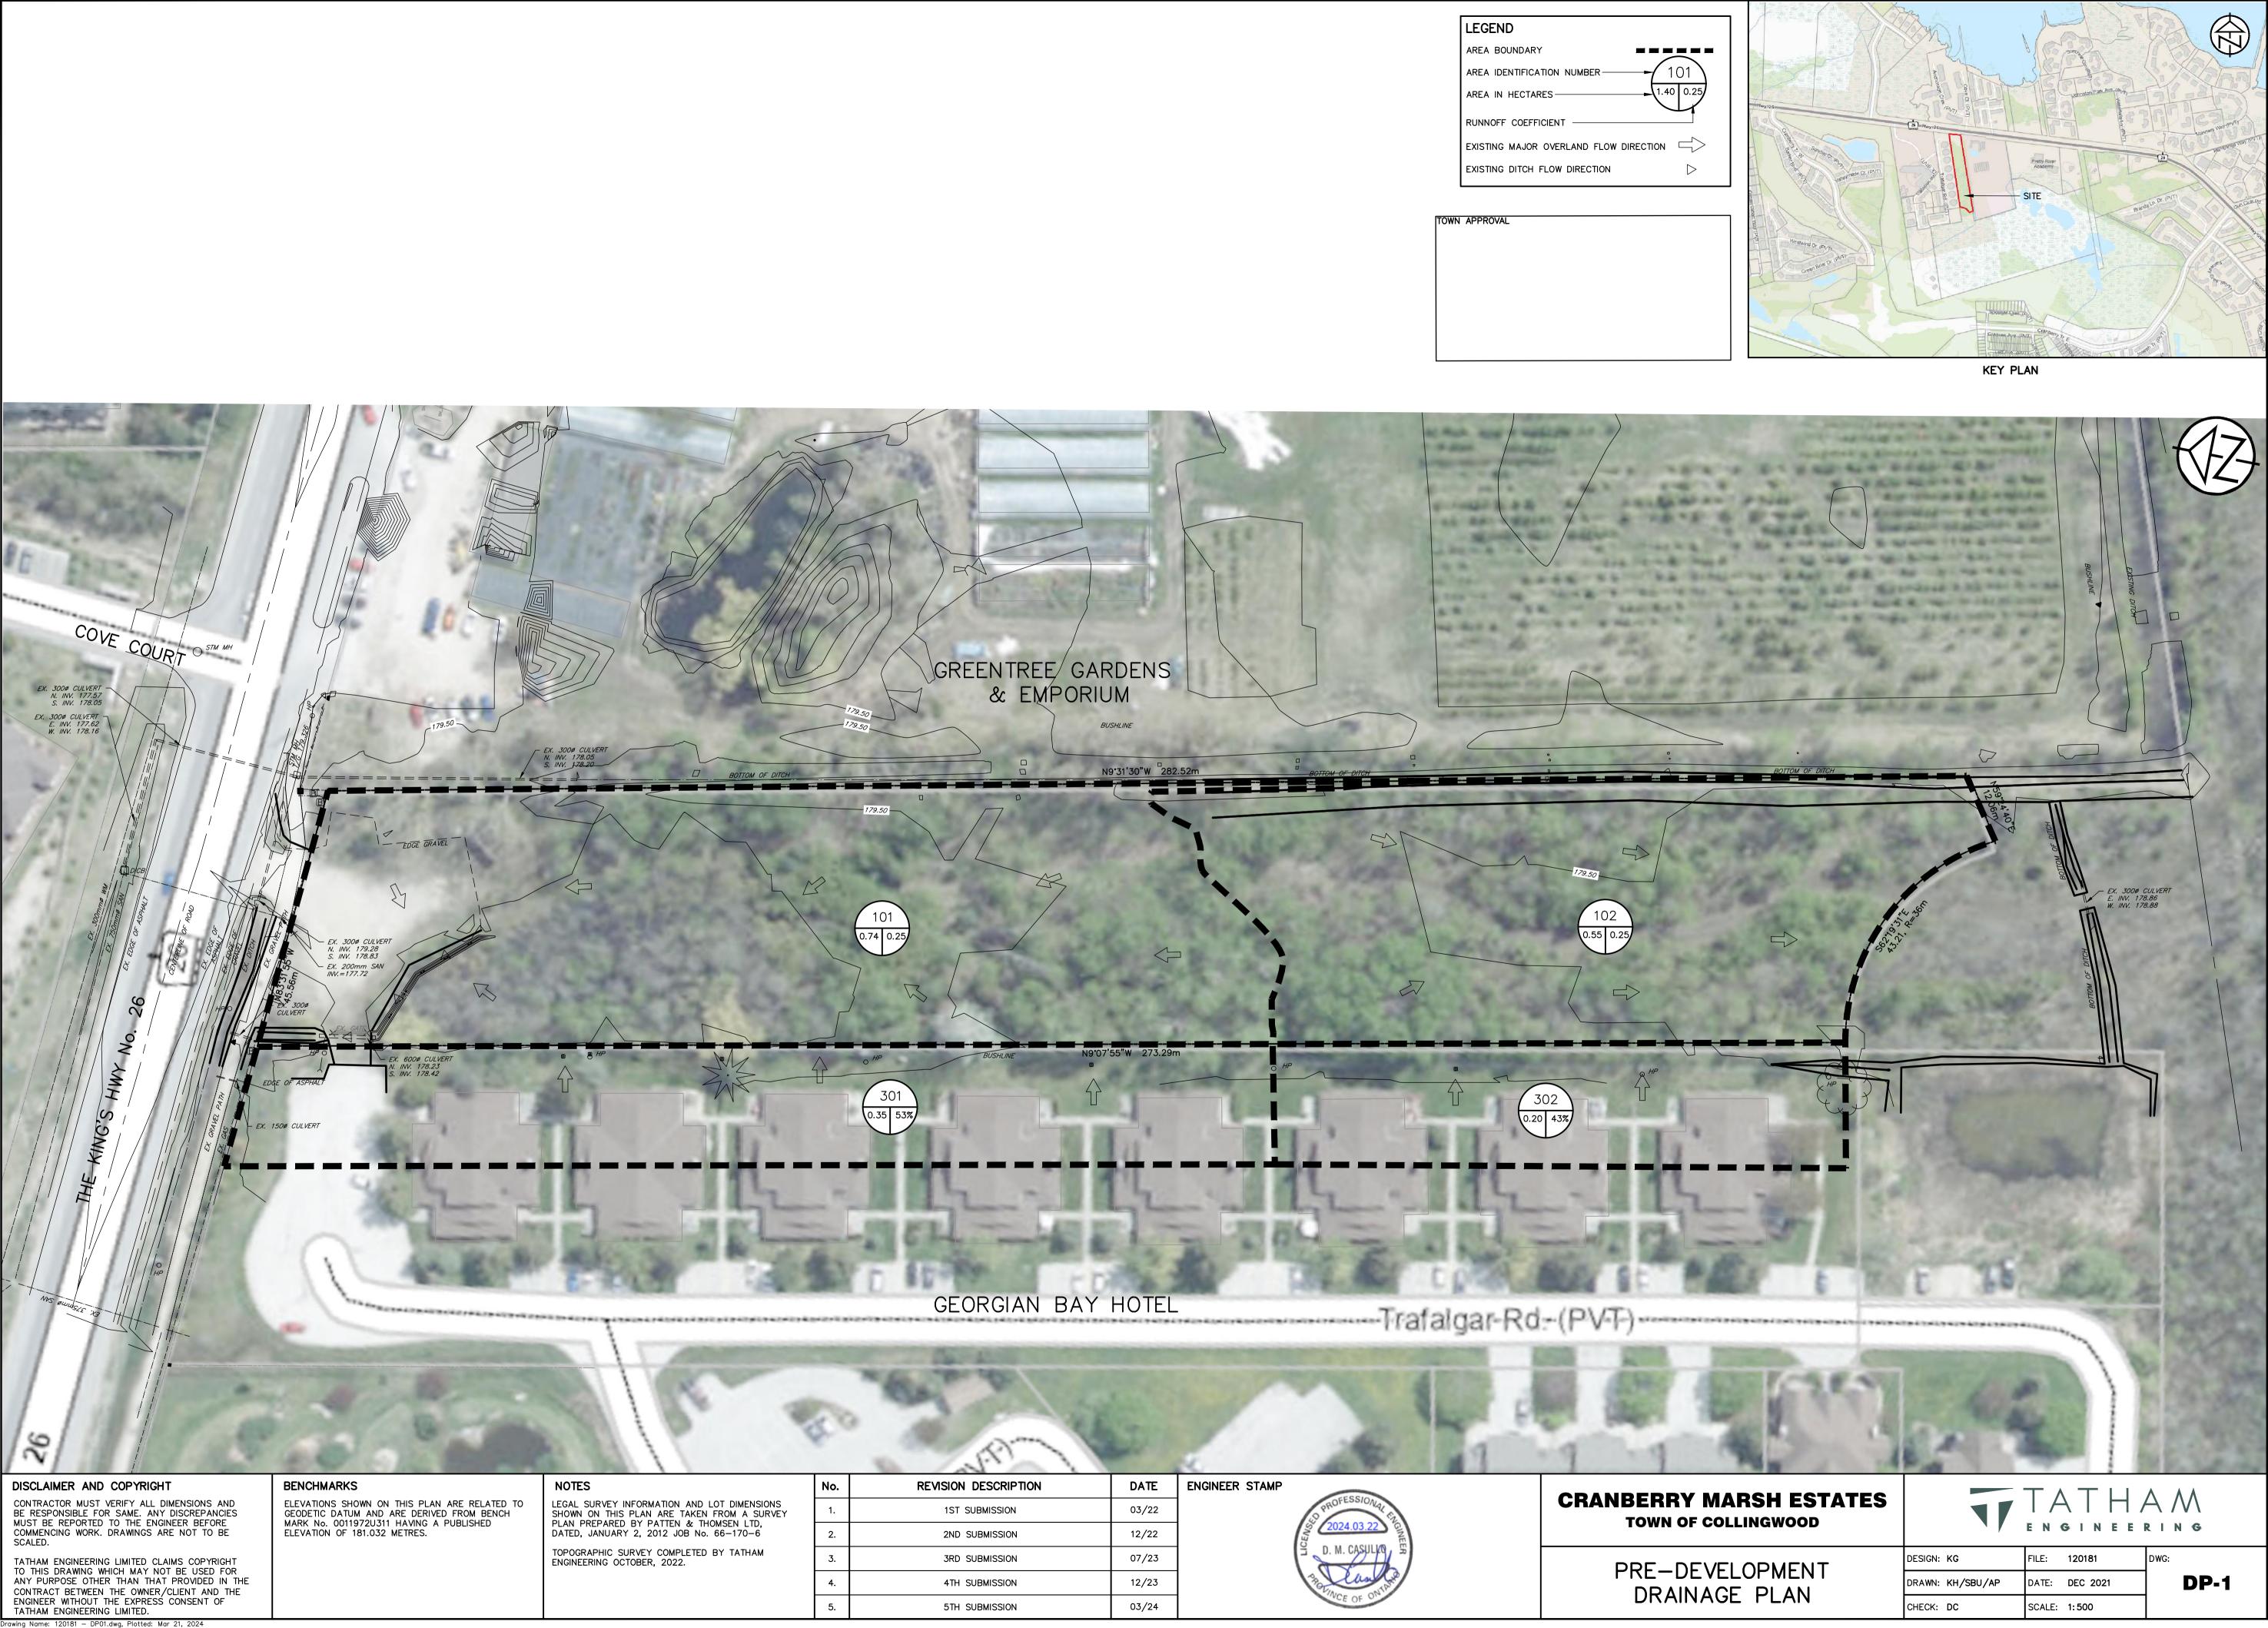

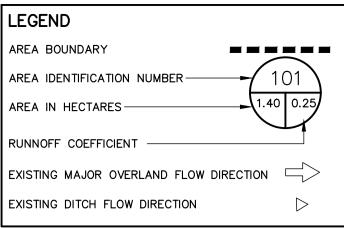

OPMENT	DESIGN: KG	FILE:	120181	DWG:
PLAN	DRAWN: KH/SBU/AP	DATE:	DEC 2021	DP-1
	CHECK: DC	SCALE:	1:500	

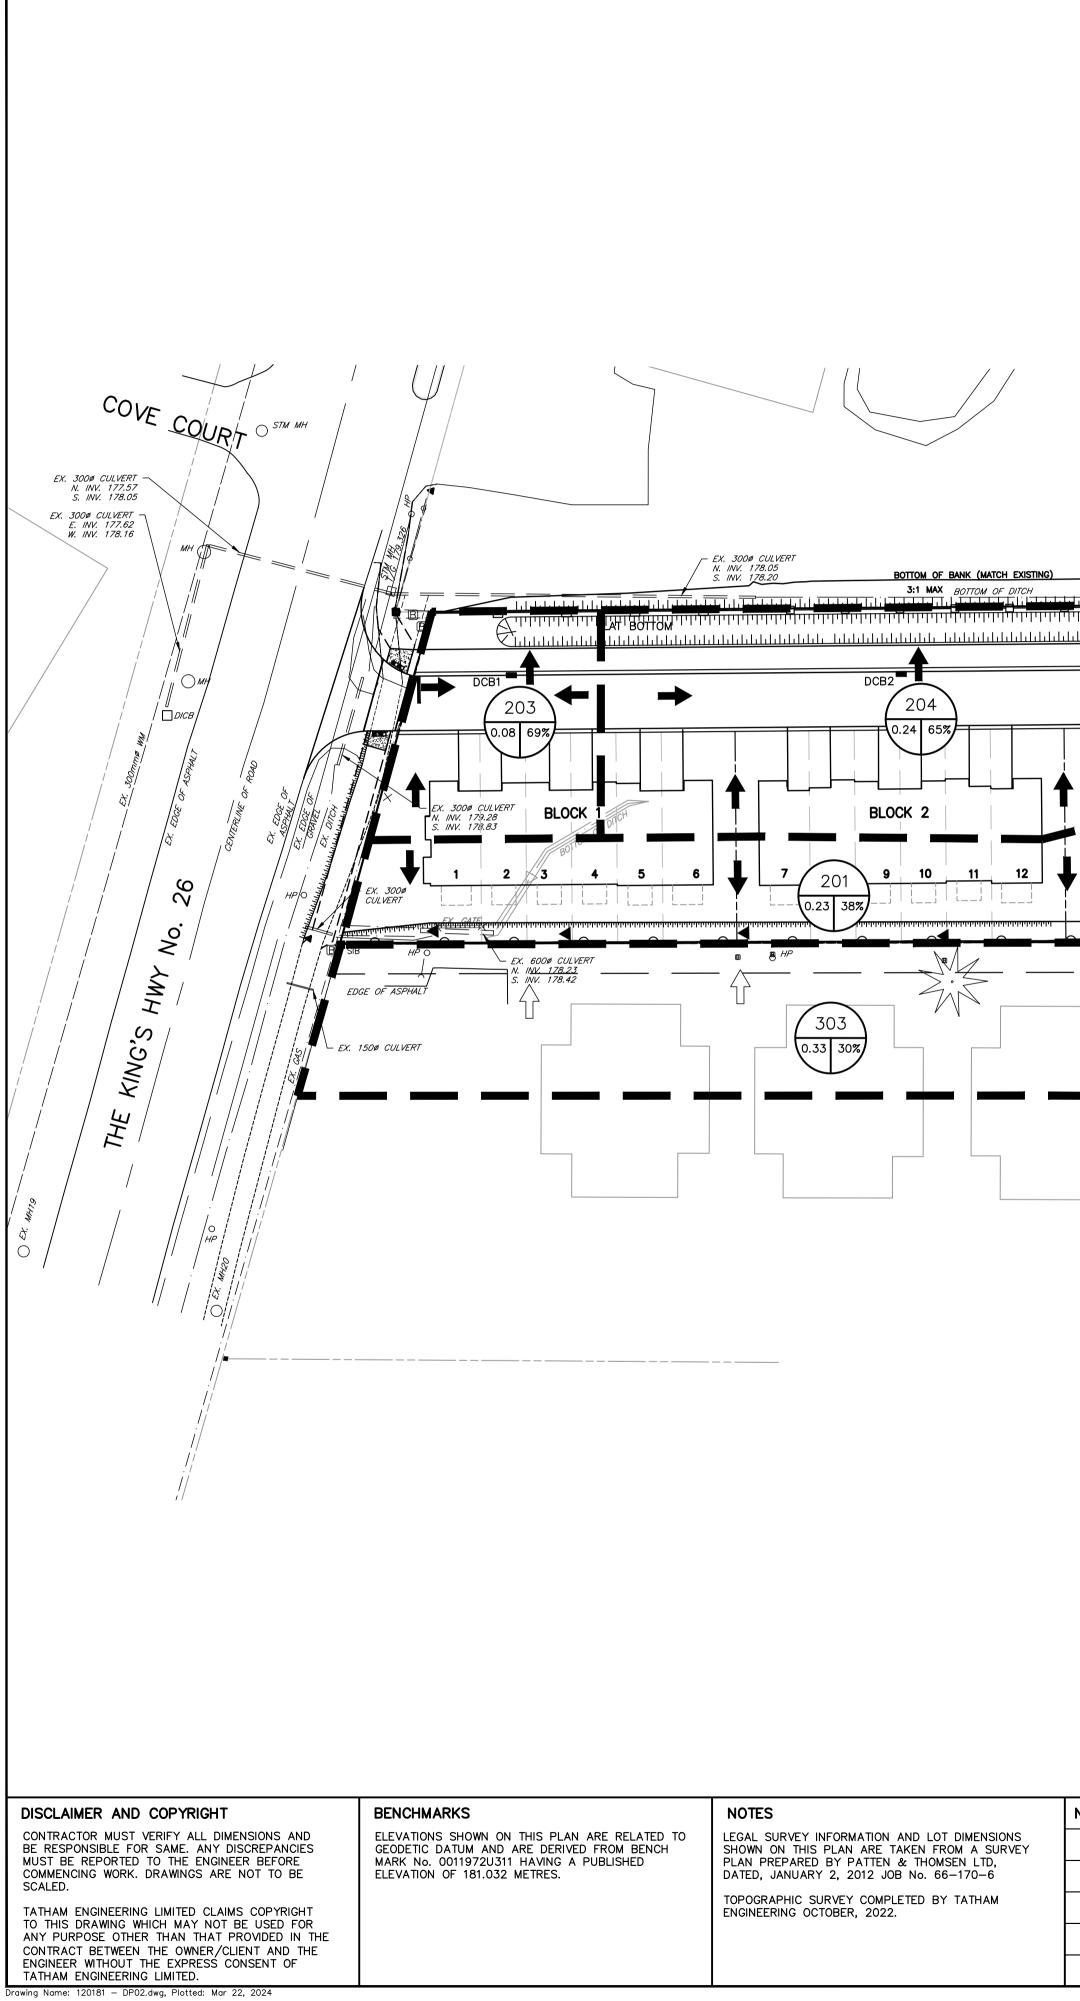

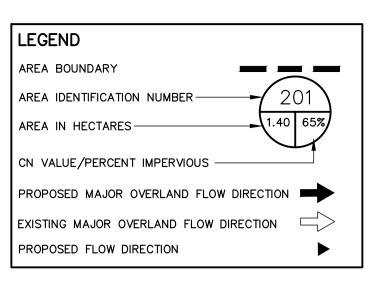

TOWN APPROVAL


GREENTREE GARDENS & EMPORIUM


BUSHLINE

			<u>ערוע ערוערע ערייע אוויע אוויע</u>		
	<u>Портики и приники и прин</u>	<u></u>	206 0.18 66%		
OCK 3	0.23 64% 0.23 64% BLOCK 4 19 20 21 22	25			20
				ининининининининининининининининининин	

GEORGAIN BAY HOTEL

No.	REVISION DESCRIPTION	DATE	ENGINEER STAMP	
2.	2ND SUBMISSION	12/22	ED PROFESSIONAL EN	CRANBERRY MAR TOWN OF COLLI
3.	UPDATE TO IMPERVIOUS VALUES	01/23	2024.03.22 G	
4.	3RD SUBMISSION	07/23	∃ D. M. CASULKQ 55	
5.	4TH SUBMISSION	12/23	3 Can Can	POST-DEVEL DRAINAGE
6.	5TH SUBMISSION	03/24	NCE OF ON	DRAINAGE

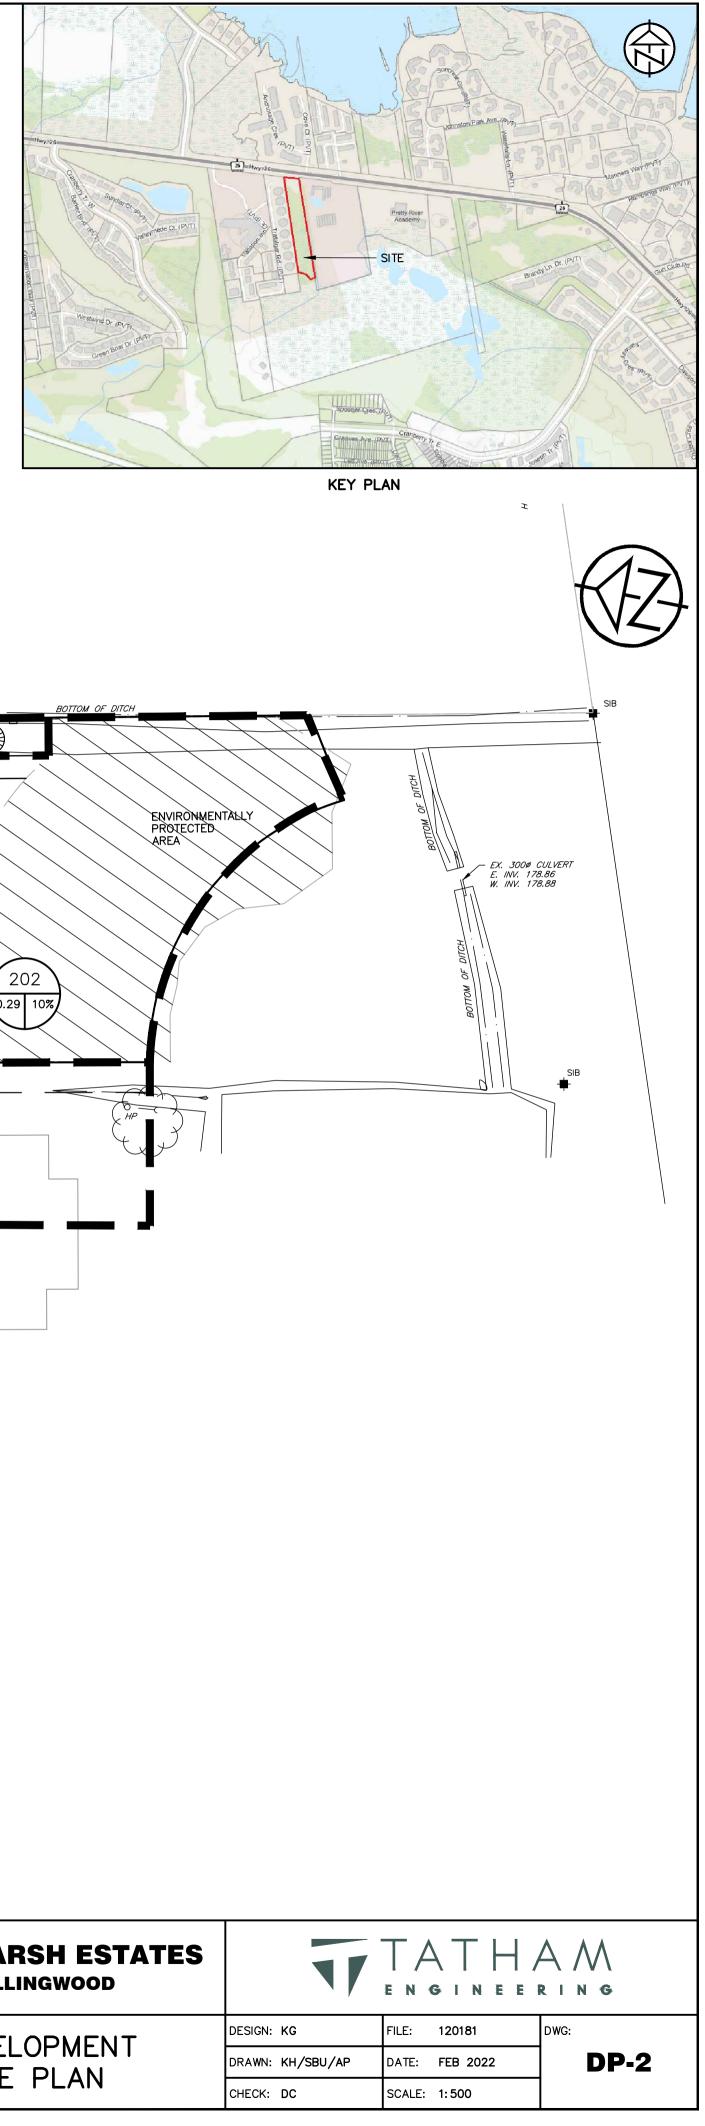

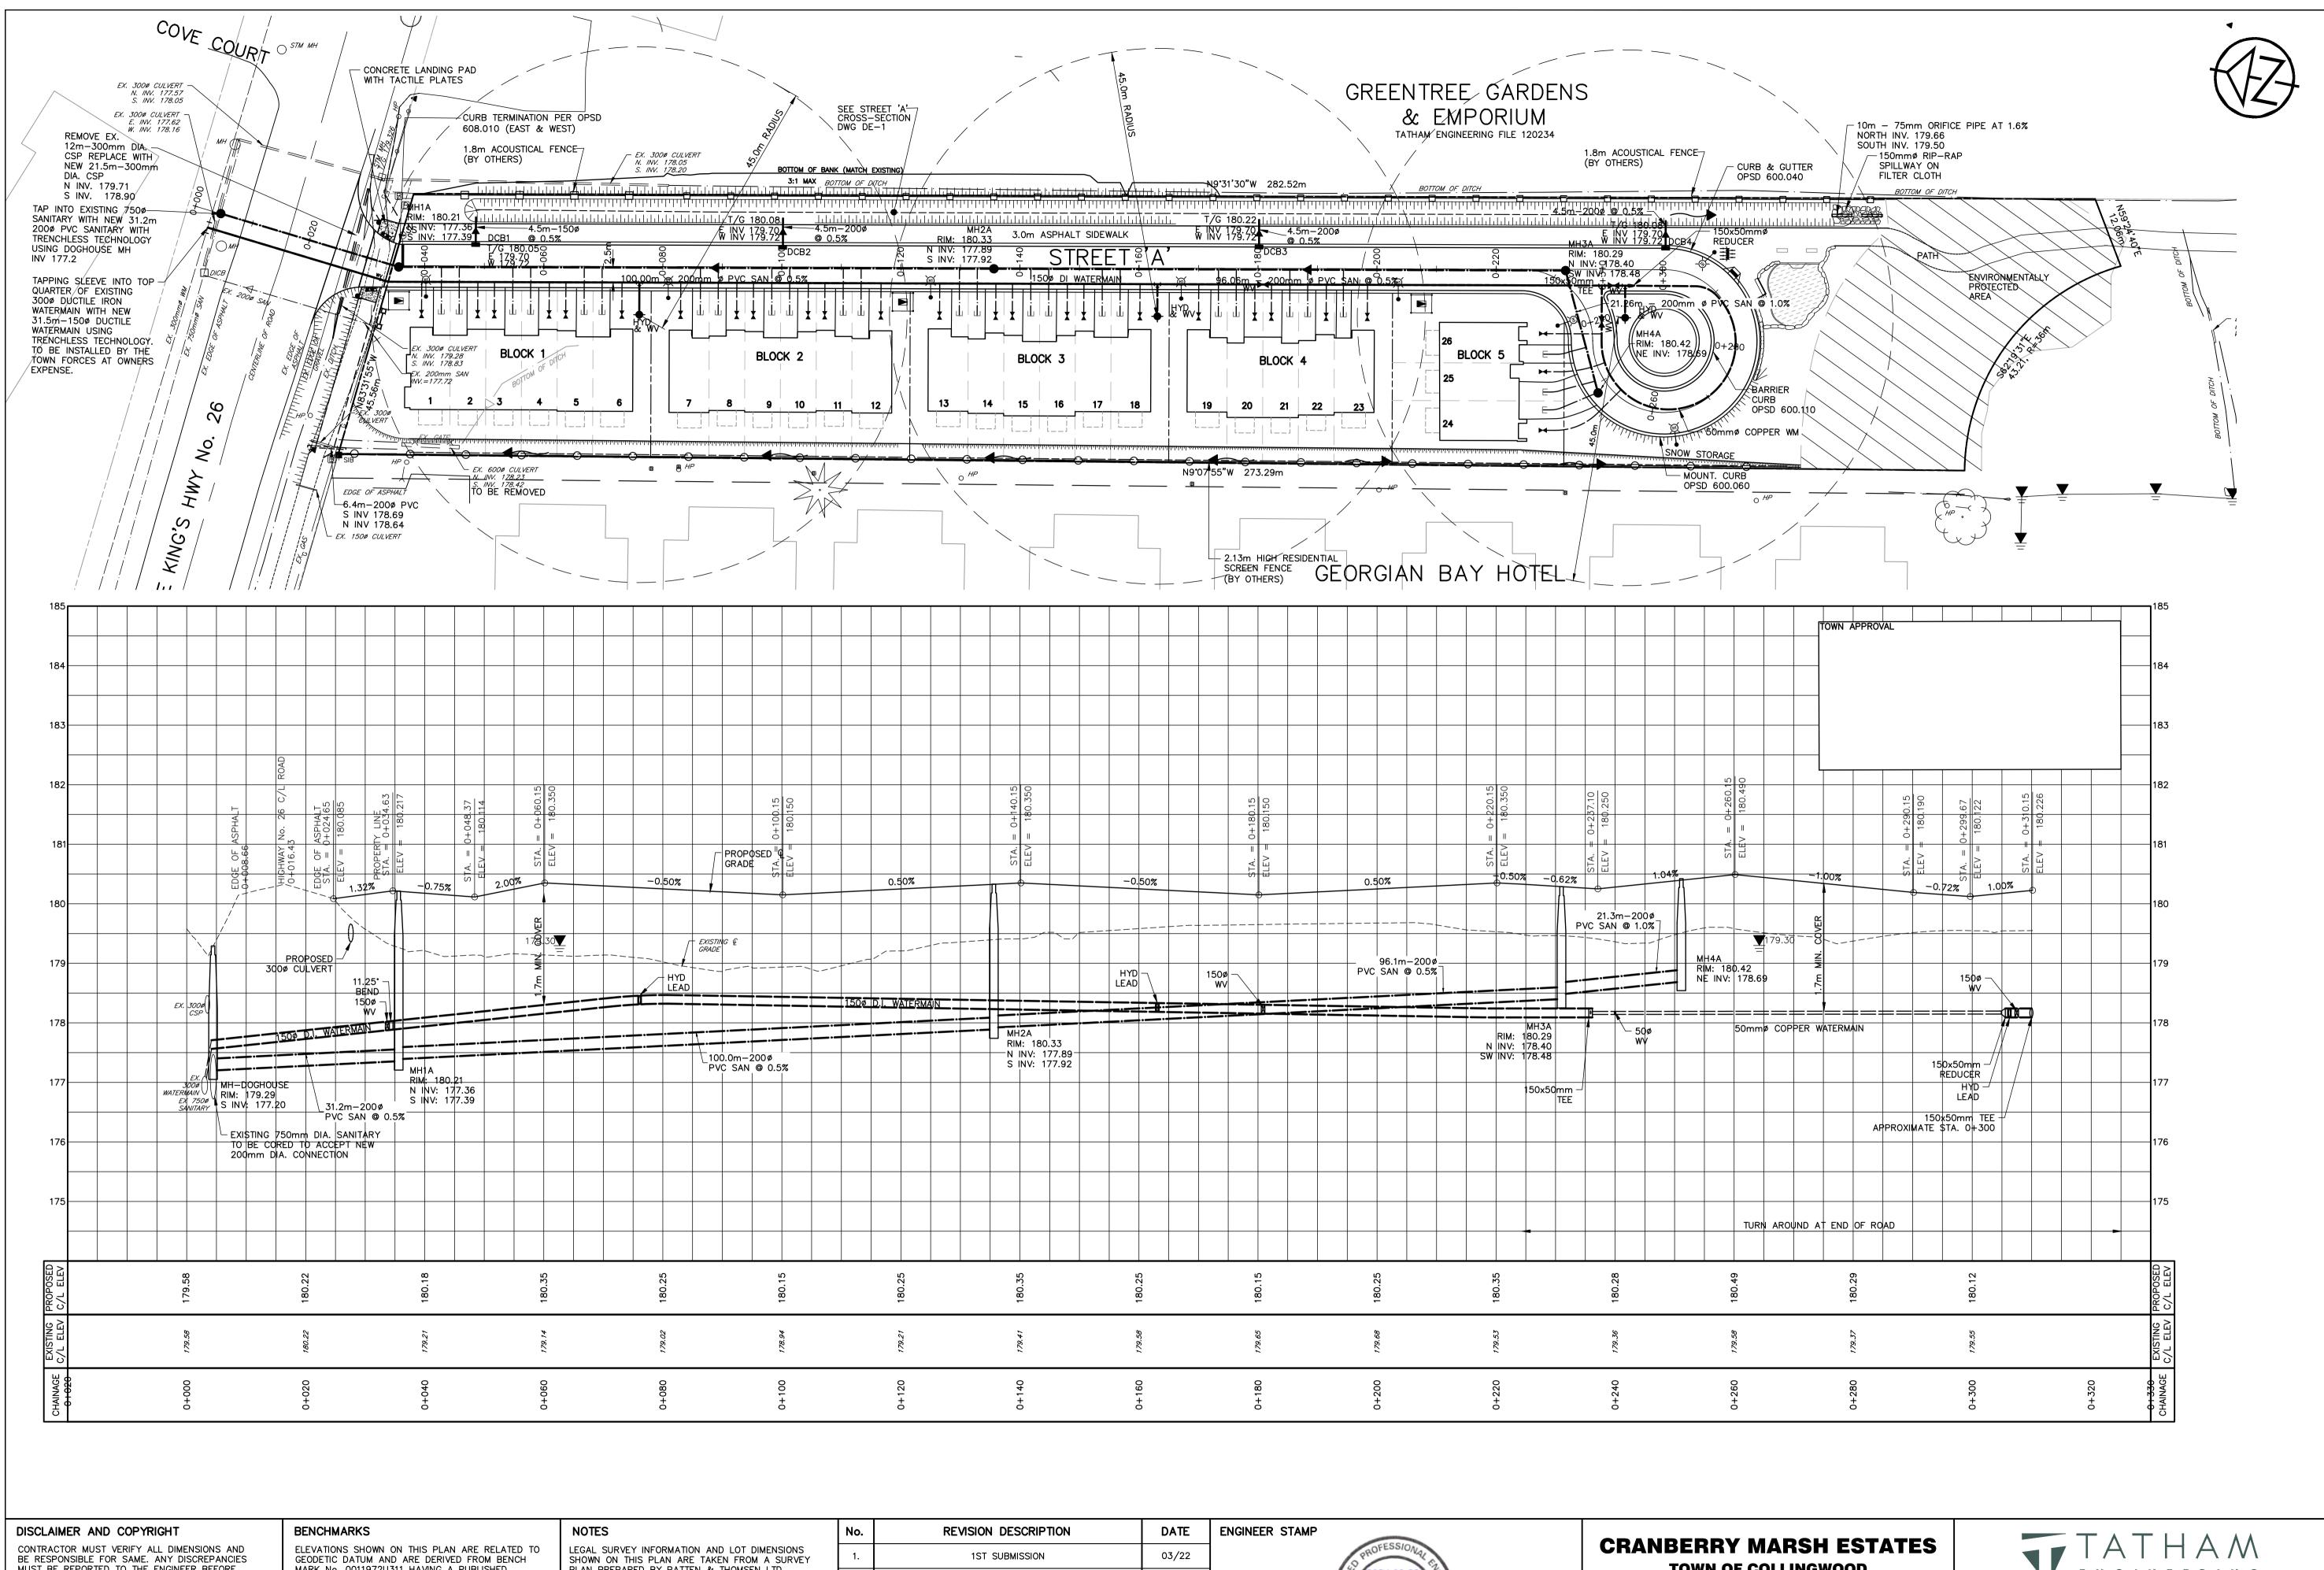

BE RESPONSIBLE FOR SAME. ANY DISCREPANCIES MUST BE REPORTED TO THE ENGINEER BEFORE COMMENCING WORK. DRAWINGS ARE NOT TO BE SCALED.


GEODETIC DATUM AND ARE DERIVED FROM BENCH MARK No. 0011972U311 HAVING A PUBLISHED ELEVATION OF 181.032 METRES.

SHOWN ON THIS PLAN ARE TAKEN FROM A SURVEY PLAN PREPARED BY PATTEN & THOMSEN LTD, DATED, JANUARY 2, 2012 JOB No. 66-170-6 TOPOGRAPHIC SURVEY COMPLETED BY TATHAM ENGINEERING OCTOBER, 2022.


TATHAM ENGINEERING LIMITED CLAIMS COPYRIGHT TO THIS DRAWING WHICH MAY NOT BE USED FOR ANY PURPOSE OTHER THAN THAT PROVIDED IN THE CONTRACT BETWEEN THE OWNER/CLIENT AND THE ENGINEER WITHOUT THE EXPRESS CONSENT OF TATHAM ENGINEERING LIMITED.

No.	REVISION DESCRIPTION	DATE	ENGINEER STAMP	
1.	1ST SUBMISSION	03/22	D PROFESSION AL EN	CRANBERRY MARSH ESTA TOWN OF COLLINGWOOD
2.	2ND SUBMISSION	12/22	2024.03.22 G	
3.	3RD SUBMISSION	07/23	☐ D. M. CASULKO 5	SITE SERVICING
4.	4TH SUBMISSION	12/23	3 Can to	PLAN AND PROFILE
5.	5TH SUBMISSION	03/24	TWCE OF ON	FLAN AND FROFILE

	ENGINEEI	RING
DESIGN: KG	FILE: 120181	DWG:
DRAWN: KH/SBU/AP	DATE: MAR 2022	PP-1
CHECK: DC	SCALE: H-1:500 V-1:50	

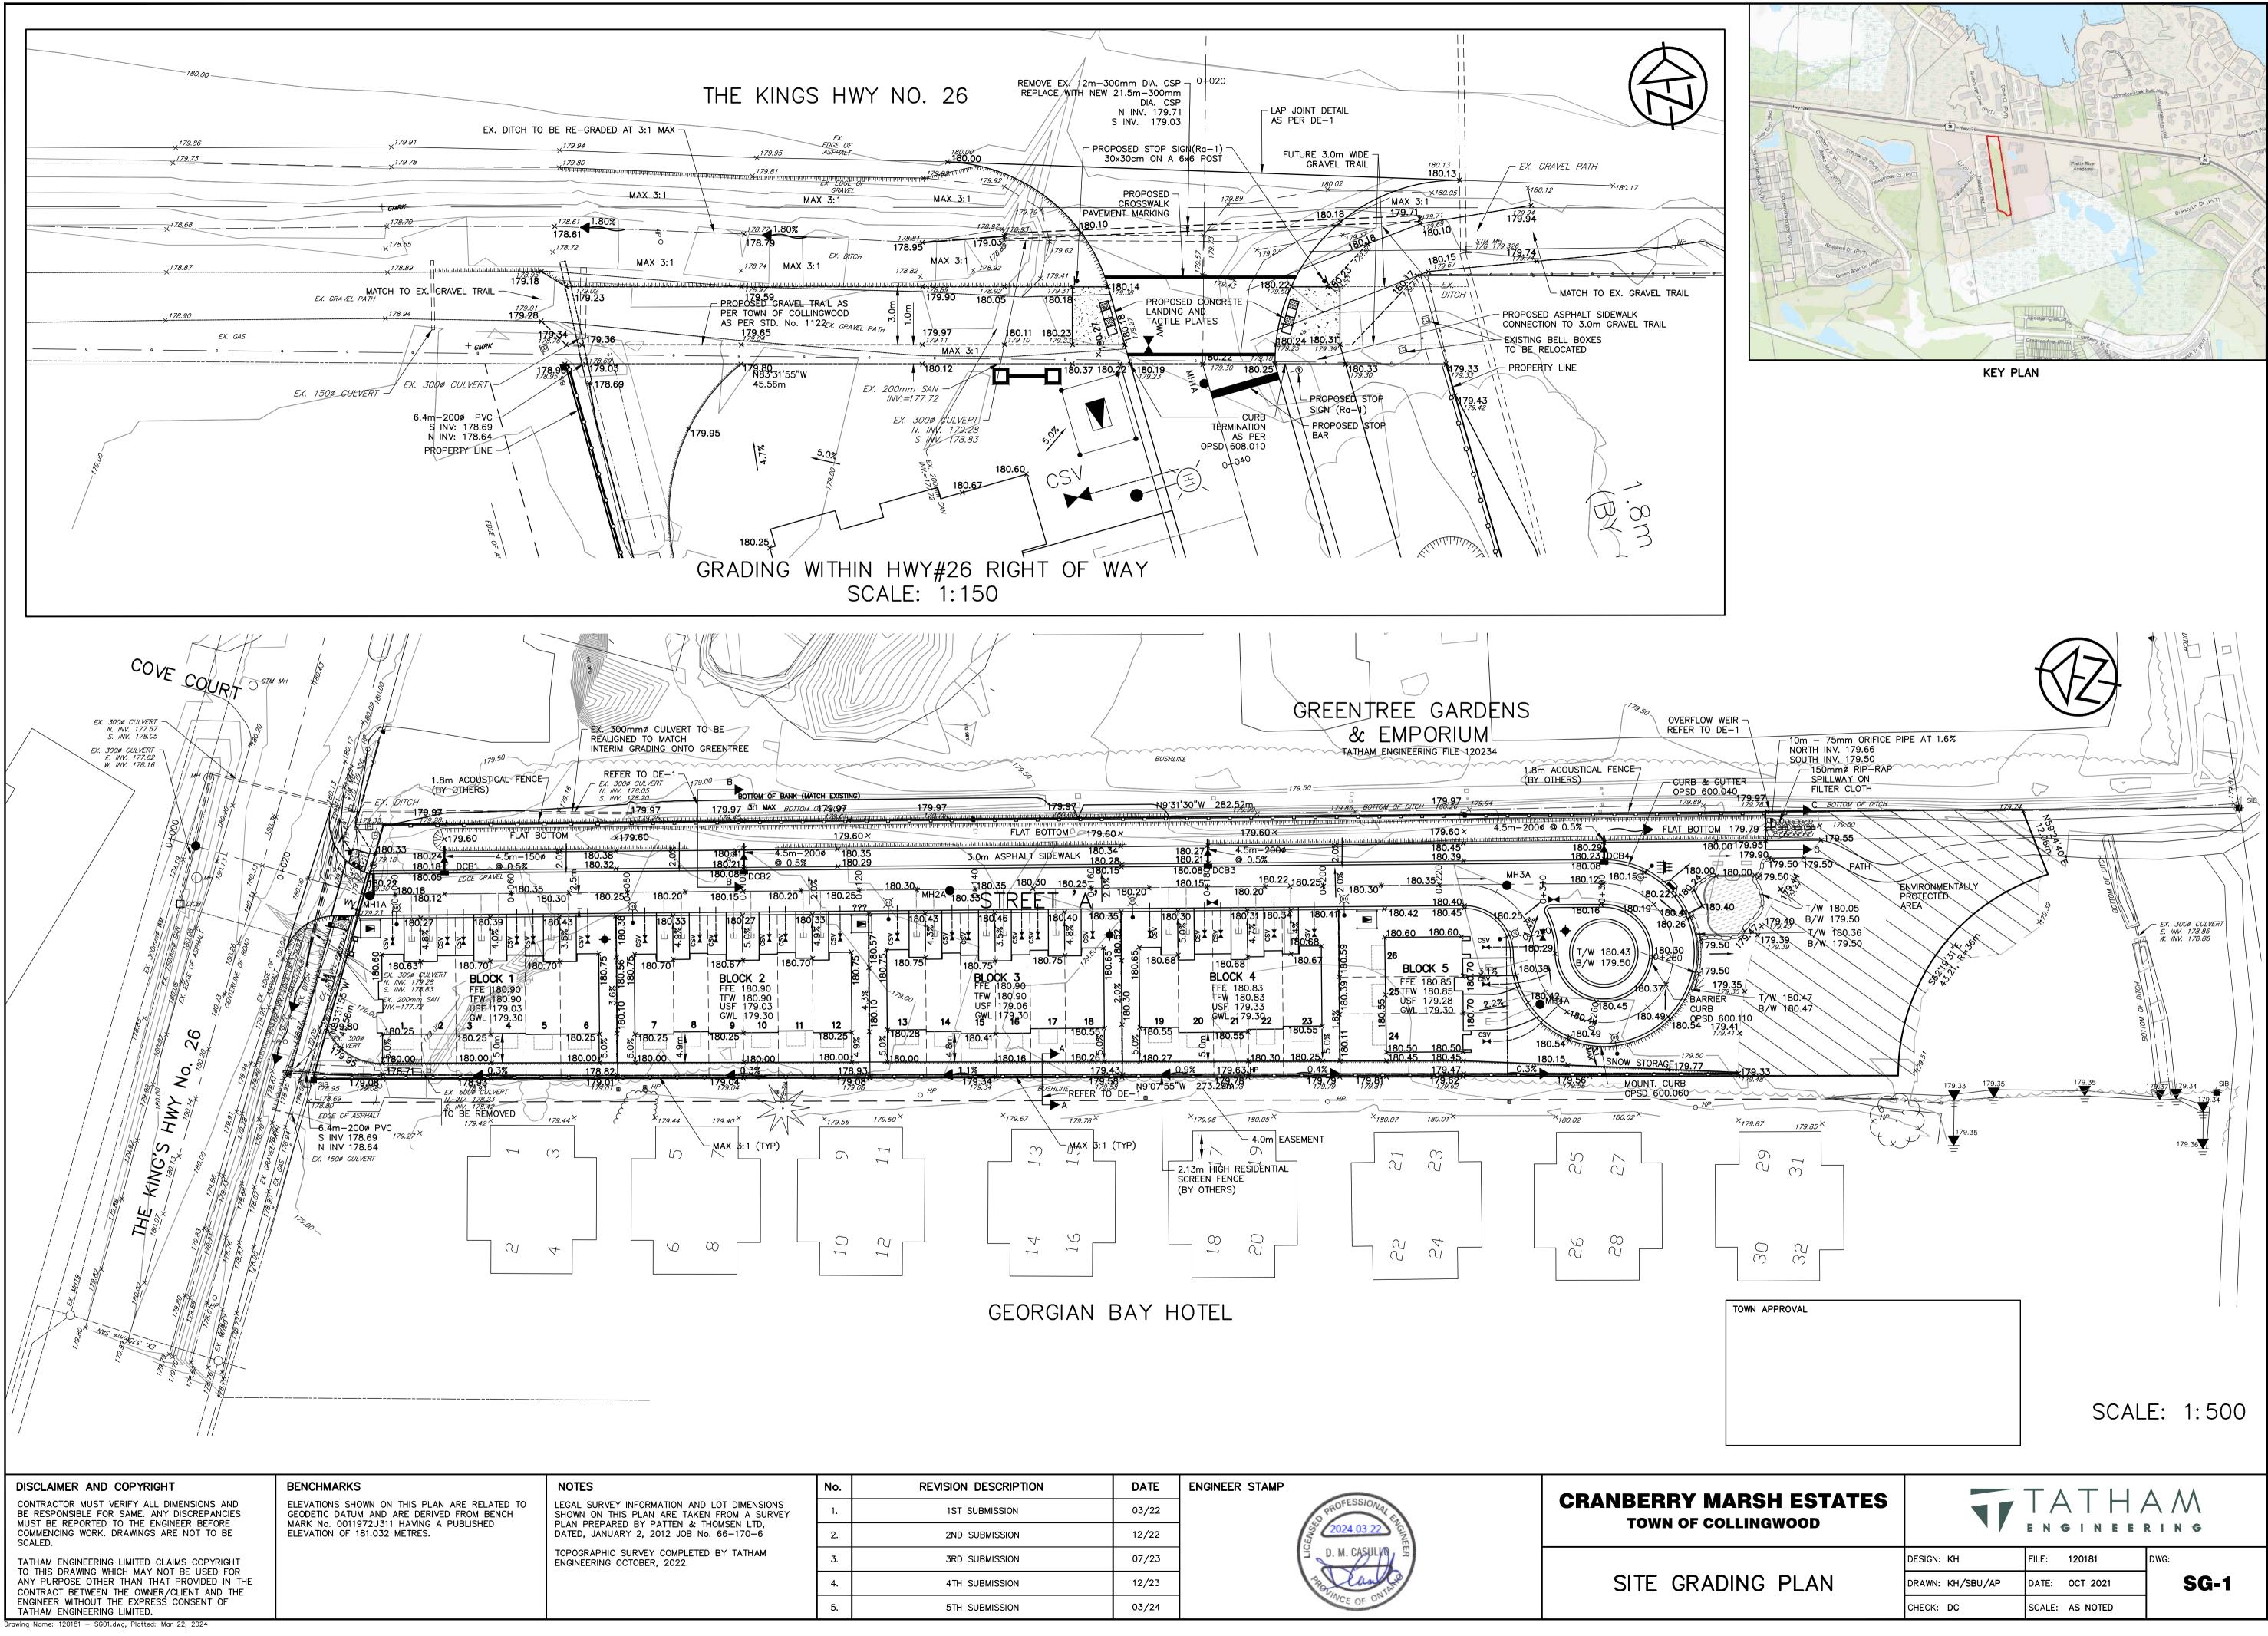

lo.	REVISION DESCRIPTION	DATE	ENGINEER STAMP				~ ~ ^
1.	1ST SUBMISSION	03/22	29 PROFESSIONAL ST				
2.	2ND SUBMISSION	12/22	2024.03.22 Kr	TOWN OF COLLINGWOOD		ENGINEE	RING
3.	3RD SUBMISSION	07/23	D. M. CASULKO		DESIGN: KH	FILE: 120181	DWG:
4.	4TH SUBMISSION	12/23			DRAWN: KH/SBU/AP	DATE: OCT 2021	SG-1
5.	5TH SUBMISSION	03/24	INCE OF ON		CHECK: DC	SCALE: AS NOTED	

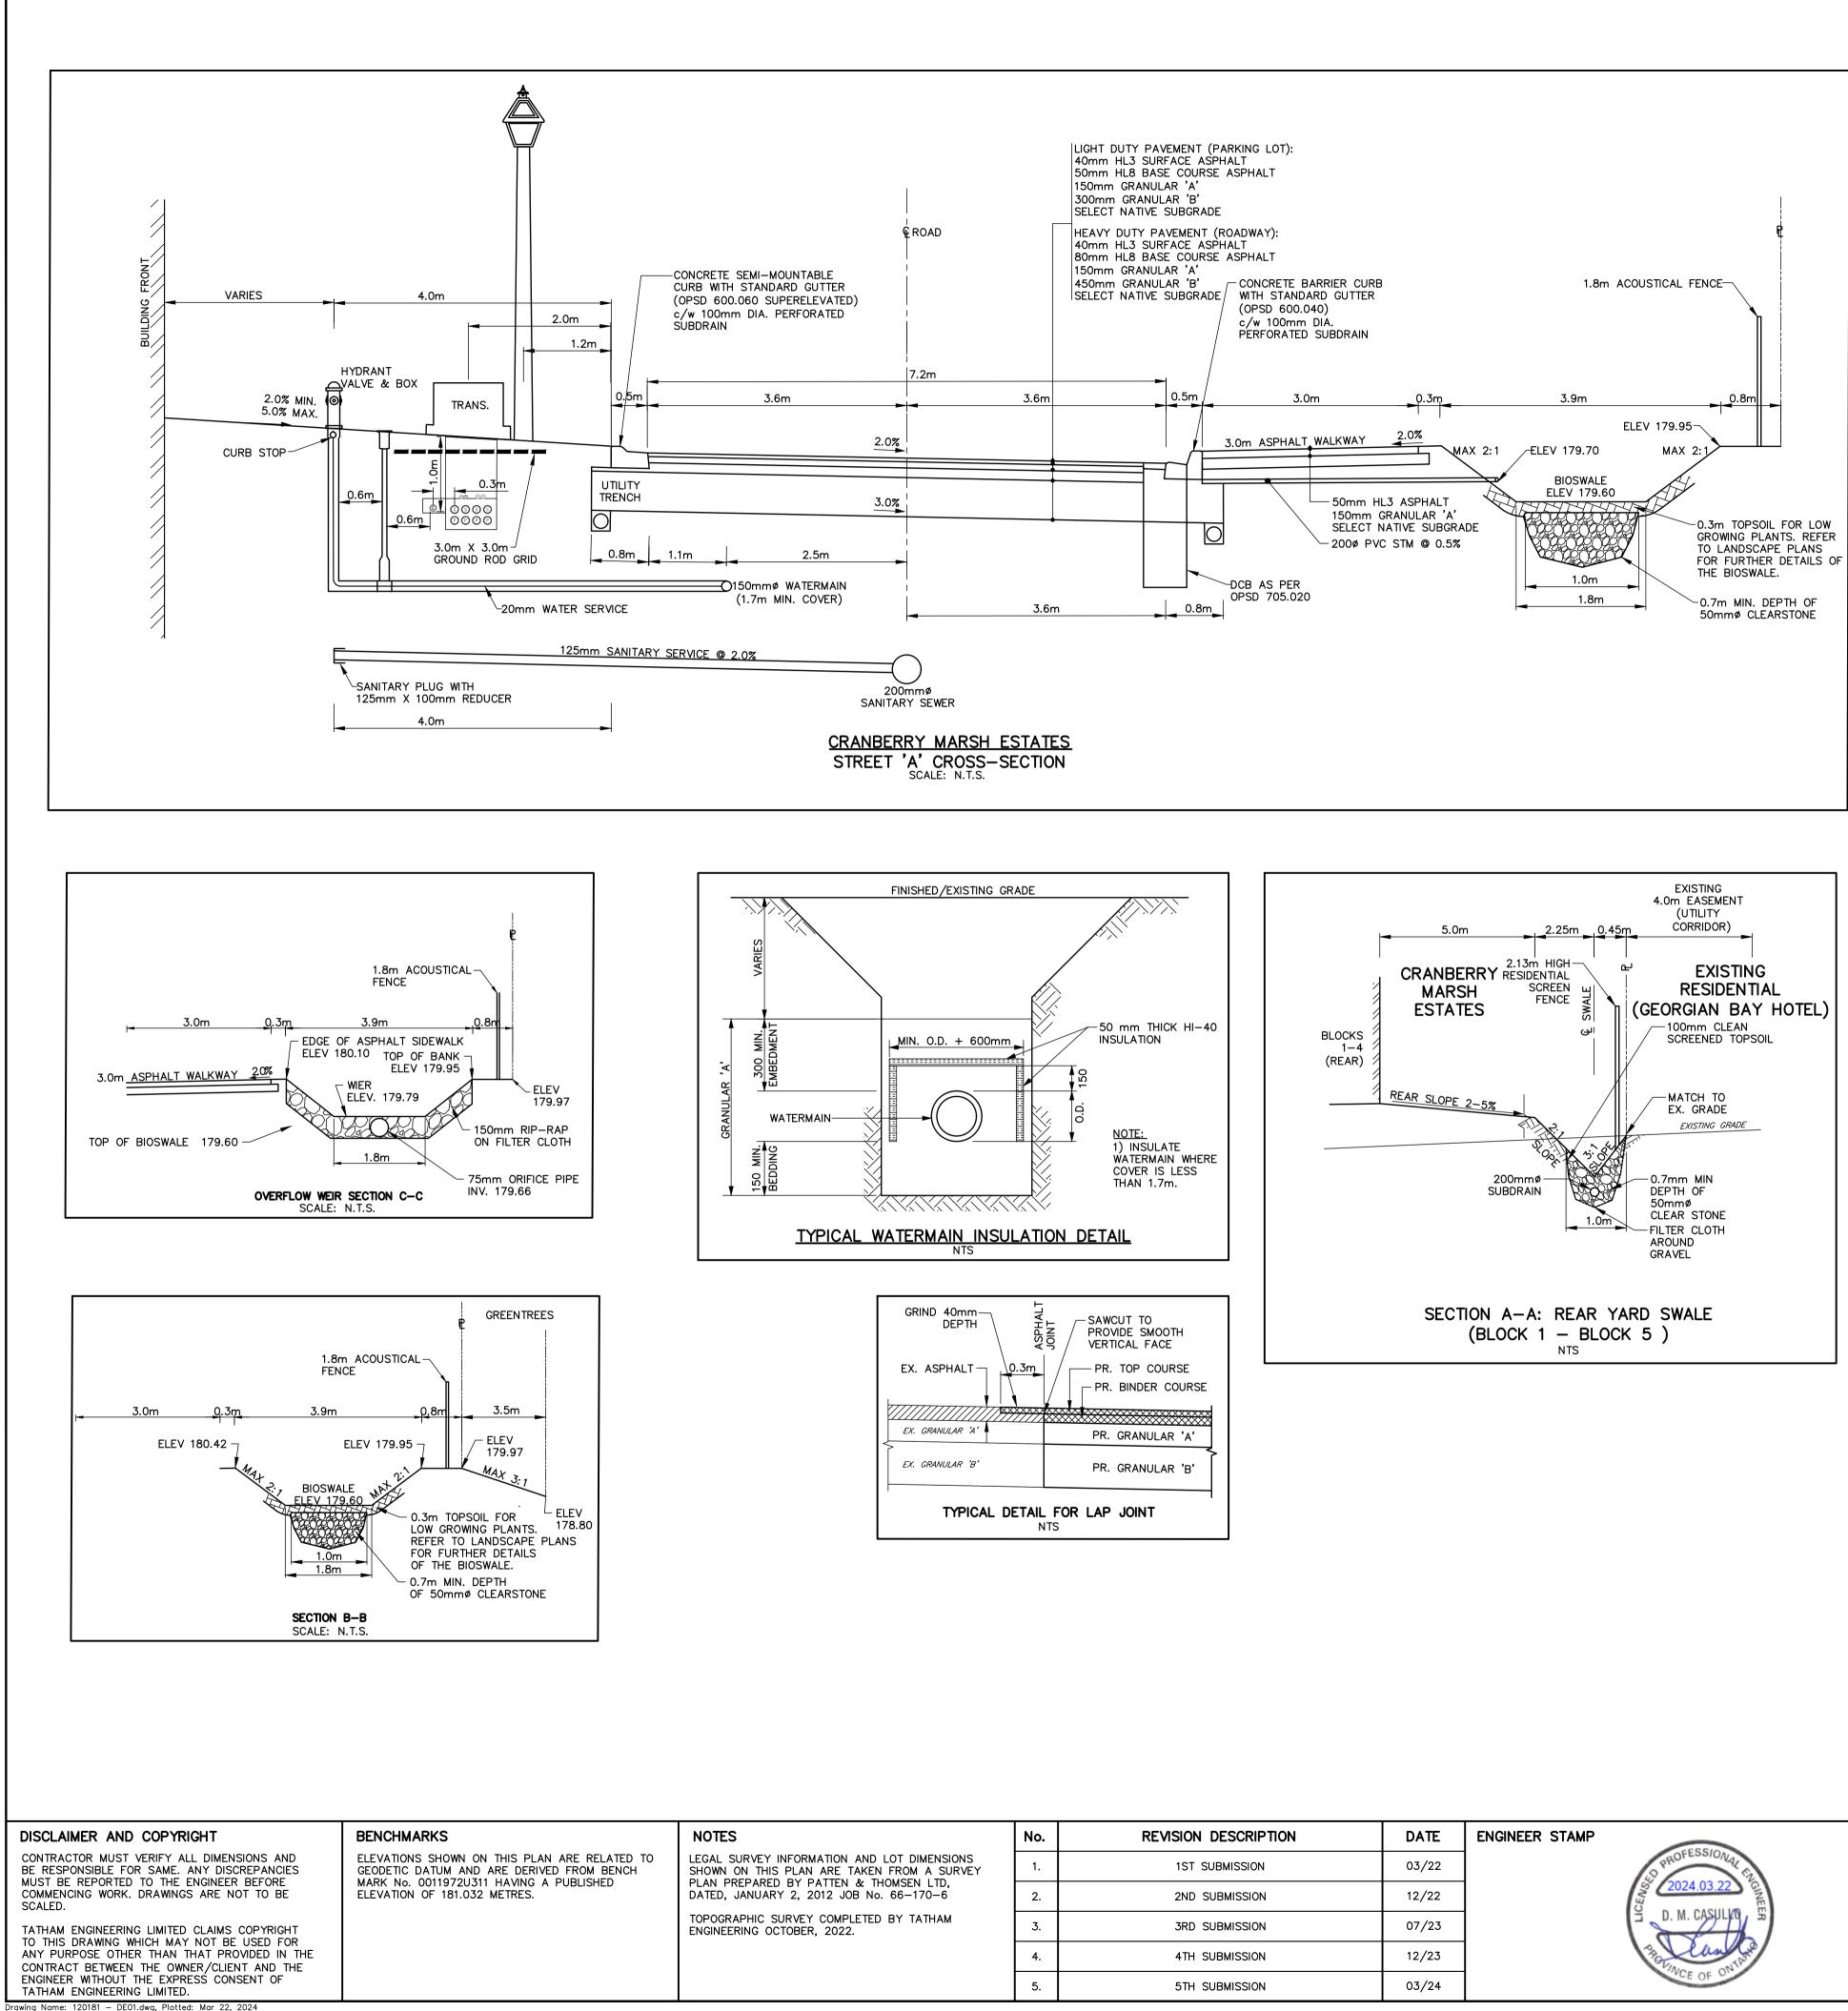

GENERAL - CONSTRUCTION

- OCCURS, TOWN OF COLLINGWOOD STANDARD TO GOVERN.
- DENSITY (SPMDD).
- SPMDD).
- MATERIAL TO AN APPROVED SITE AS DIRECTED BY ENGINEER.

- RAISED PRIOR TO PLACEMENT OF FINAL COURSE HL3 ASPHALT.
- L) ALL DISTURBED AREAS TO BE REINSTATED TO PREVIOUS CONDITION OR BETTER.
- PRIOR TO COMMENCING WORK AND CO-ORDINATE CONSTRUCTION ACCORDINGLY.
- O) CLEARING, GRUBBING AND REMOVAL OF SURFACE BOULDERS TO OPSS 201.
- P) GRADING TO OPSS 206.
- Q) COMPACTING TO OPSS 501. R) DUST SUPPRESSANTS TO OPSS 506.

SANITARY SEWERS

- A) MAINTENANCE HOLES TO OPSD 701.010 AND 701.030. B) BENCHING TO OPSD - 701.021.
- C) STEPS TO OPSD 405.010. E) FRAMES AND COVERS TO OPSD - 401.030 (WATER TIGHT COVER).
- F) PIPE SUPPORT AT MAINTENANCE HOLES AS PER OPSD 708.020.
- 410, 421 AND ALL SPECIFICATIONS REFERENCED WITHIN THESE SECTIONS.
- J) SERVICE CONNECTION TO OPSD 1006.020, GRANULAR A BEDDING AND EMBEDMENT. INSULATION TO BE MINIMUM 50 mm THICK AND HAVE A MINIMUM WIDTH OF 1.2m.

WATER MAINS

- A) THRUST BLOCKS TO OPSD-1103.010 AND 1103.020 WHERE SUITABLE SOILS ARE ENCOUNTERED. B) MINIMUM COVER ON WATER MAIN AND SERVICES TO BE 1.7 m.

- REFERENCED WITHIN THESE SECTIONS.
- AN APPROVED CONTRACTOR WITH TCWD INSPECTION, ALL AT DEVELOPER'S COST.

- THIS WORK MUST BE SUBMITTED TO TOWD FOR APPROVAL.
- L) NO WATER VALVES ARE TO BE OPERATED WITHOUT TOWD APPROVAL. STORM SEWERS
- INLET CATCH BASINS TO OPSD 705.010 WITHOUT SUMP.
- 400.120.
- ACTIVITIES, AND CLEANED OUT AS REQUIRED PRIOR TO ASSUMPTION OF THE WORK.
- GRATING IN ACCORDANCE WITH OPSD 804.050.

ROAD AND PARKING

- SUBGRADE TO BE PROOF ROLLED AND CERTIFIED PRIOR TO PLACING GRANULAR 'B'. B) GRANULAR 'A' AND 'B' BASE TO BE COMPACTED TO 100% OF THE MATERIAL'S RESPECTIVE SPMDD.
- SUBDRAINS TO BE CONSTRUCTED IN ACCORDANCE WITH OPSS 405.

- I) ALL FIRE ROUTE SIGNAGE TO BE AS PER TOWN OF COLLINGWOOD BY-LAW 96-37.
- J) ENTRANCE AS PER OPSD 350.010, SIDEWALKS TO OPSD 310.050 AND 310.010.

MATERIALS

- A) SANITARY SEWER SDR-35 PVC, SANITARY SERVICES SDR 28 PVC C) WATER SERVICE CONNECTIONS TO BE TYPE 'K' COPPER PIPE.
- E) MECHANICAL JOINT DUCTILE FITTINGS AWWA/ANSI C153/A21.53.
- G) LIVE TAP SADDLES EPOXY COATED c/w STAINLESS STEEL BOLTS. H) LIVE TAP VALVE - RESILIENT SEATED RSGV, LIVE TAPE VALVE, OPEN LE.
-) FILTER FABRIC TERRAFIX 270R OR APPROVED EQUAL.
- K) ALL SPECIFIED AGGREGATES TO OPSD 1010. L) INSULATION - STRYROFOAM HI-40.
- M) ALL HYDRANTS SHALL BE, CANADA VALVE, CENTURY NO. 1 OPEN LEFT WITH 2 CSA HOSE PORTS, ONE STORZ 4"PUMPER PORT, AND A BREAK AWAY TYPE 6"MJ BASE.

CRANBERRY MARS TOWN OF COLLIN DETAILS &

A) ALL WORK TO BE CARRIED OUT IN ACCORDANCE WITH TOWN OF COLLINGWOOD STANDARDS, O.P.S.D. AND O.P.S.S. WHERE CONFLICT B) TRENCH BACKFILL TO OPSD 802.010 TO BE SELECT NATIVE MATERIAL OR IMPORTED SELECT SUBGRADE TO OPSS 1010. BACKFILL TO BE PLACED IN MAXIMUM 200 mm THICK LIFTS AND COMPACTED TO 95% OF THE MATERIAL'S STANDARD PROCTOR MAXIMUM DRY

C) PIPE BEDDING TO BE GRANULAR 'A' PIPE COVER TO BE GRANULAR 'B' MAX. AGGREGATE SIZE 25mm FOR RIGID PIPE AND GRANULAR 'A' FOR FLEXIBLE PIPE. (MINIMUM BEDDING DEPTH 150 mm, MINIMUM COVER 300mm, COMPACTED TO A MINIMUM 95%

D) CLEAR STONE WRAPPED IN FILTER FABRIC CAN BE SUBSTITUTED FOR EMBEDMENT MATERIAL IF APPROVED BY THE ENGINEER. E) ALL TOPSOIL AND EARTH EXCAVATION TO BE STOCK PILED OR REMOVED TO OPSS 180. MANAGEMENT AND DISPOSAL OF EXCESS

F) THE OWNER'S ENGINEER SHALL PROVIDE BENCH MARK ELEVATIONS AND HORIZONTAL ALIGNMENT REFERENCE FOR THE CONTRACTOR. THE CONTRACTOR SHALL BE RESPONSIBLE FOR THE DETAILED LAYOUT OF THE WORK. G) ALL PROPERTY BARS TO BE PRESERVED AND REPLACED BY O.L.S. AT CONTRACTOR'S EXPENSE IF REMOVED DURING CONSTRUCTION.

H) ALL MAINTENANCE HOLE AND CATCHBASIN FRAMES AND COVERS TO BE SET TO BASE COURSE HL8 ASPHALT ELEVATION AND THE CONTRACTOR SHALL MAKE HIS OWN ARRANGEMENTS FOR THE SUPPLY OF TEMPORARY WATER AND POWER.

DEWATERING TO BE CARRIED OUT IN ACCORDANCE WITH OPSS-517 AND 518 TO MAINTAIN ALL TRENCHES IN A DRY CONDITION. K) ALL ENGINE DRIVEN PUMPS TO BE ADEQUATELY SILENCED, SUITABLE FOR OPERATION IN A RESIDENTIAL DISTRICT.

M) THE CONTRACTOR IS RESPONSIBLE FOR PRESERVATION OF ALL EXISTING FACILITIES AS WELL AS NOTIFYING ALL UTILITY COMPANIES N) ALL SIGNAGE TO BE LAWFULLY ERECTED AND MAINTAINED IN ACCORDANCE TO THE TOWN SIGN BY-LAW.

S) TREE REMOVALS AND/OR TRANSPLANTS TO BE COMPLETED OUTSIDE OF MIGRATORY BIRDS NESTING SEASON FROM APRIL 1ST TO AUGUST 31ST. REMOVALS MAY TAKE PLACE DURING THIS RESTRICTED TIME ONLY IF THE REQUIREMENTS OF MIGRATING BIRDS CONVENTION ACT ARE MET AND NESTING ACTIVITY IS ROUTINELY MONITORED BY QUALIFIED INDIVIDUALS (I.E. WILDLIFE BIOLOGIST).

D) FROST STRAPS SHALL BE INSTALLED ON ALL MAINTENANCE HOLE AS PER OPSD - 701.100

G) ALL MAINTENANCE HOLES. UNLESS EXPRESSLY IDENTIFIED ARE 1200 mm DIAMETER WITH WATER TIGHT INSERTS. H) GENERAL INSTALLATION AND TESTING OF SEWERS AND APPURTENANCES TO BE IN ACCORDANCE WITH O.P.S.S. 407, 408, 409 (CCTV), I) SERVICE CONNECTIONS TO BE 125 mm DIA., TERMINNATED WHERE SPECIFIED ON THE DRAWING COMPLETE WITH PLUG AND MARKED WITH A 38mm X 89mm POST PAINTED GREEN FROM THE INVERT OF THE SERVICE TO 600 mm ABOVE GRADE. K) RIGID BOARD INSULATION (HI-40) REQUIRED FOR FROST PROTECTION OF SEWER WITH LESS THAN 1.2 m MINIMUM COVER.

C) GATE VALVES, BENDS AND FITTINGS TO BE CONNECTED WITH ROMAC GRIP RING RESTRAINING CLAMP. D) CLEARANCE BETWEEN WATER MAINS AND SEWERS TO BE A MINIMUM OF 0.5m VERTICAL WHERE WATER MAIN IS BELOW SEWER OR 2.5m MINIMUM HORIZONTAL SEPARATION. WHERE WATER MAIN IS ABOVE SEWER, THE MINIMUM SEPARATION TO BE 150 mm (BEDDING MATERIAL). E) GENERAL INSTALLATION AND TESTING OF WATER MAIN AND APPURTENANCES TO BE IN ACCORDANCE WITH O.P.S.S. 701 AND ALL SPECIFICATIONS

F) ALL WORK ON TOWN PROPERTY AND ON TOWN OF COLLINGWOOD WATER DEPARTMENT (TCWD) WATER MAINS MUST BE UNDERTAKEN BY TCWD OR H) SERVICE CONNECTIONS TO OPSD-1104.010, 100 mm GRANULAR 'A' EMBEDMENT AND COVER OVER PIPE. TERMINATE WHERE SPECIFIED ON

DRAWING C/W CURB STOP AND BOX, TESTING TAIL TO SURFACE ATTACHED TO A 38mm x 89mm MARKER POST PAINTED BLUE FROM THE INVERT OF THE SERVICE TO 600 mm ABOVE GRADE. I) ALL SERVICES ARE TO BE CONSTRUCTED IN ACCORDANCE WITH TOWN STANDARDS. I) WATER MAIN SERVICES - 20mm TYPE K COPPER, MAIN STOPS TO 201-A3H3, 3/4", BALL STYLE. AWWA THREAD BY COMPRESSION CAMBRIDGE BRASS. CURB STOPS TO 203-H3H3. 3/4" BALL STYLE WITH DRAIN, COMPRESSION JOINT CAMBRIDGE BRASS. SERVICE BOXES TO NUMBER 7, D-1 CLOW OR MUELLER WITH 24" BLACK RODS STRAIGHT OR OTHERWISE NOTED ON DRAWINGS. J) ALL WATER TESTING AND WATER MAIN CHLORINATION WILL BE CONDUCTED BY TOWD AT THE DEVELOPER'S COST. WATER MAINS ARE NOT TO BE CONNECTED TO THE EXISTING WATER MAINS UNTIL BACTERIOLOGICAL TESTING HAS BEEN SUCCESSFULLY COMPLETED. NEW WATER MAINS CAN NOT BE CONNECTED TO EXISTING MAINS UNTIL THEY HAVE PASSED BACTERIOLOGICAL TESTING AND AS SUCH A TEMPORARY BACKFLOW PREVENTOR

WILL NEED TO BE INSTALLED BETWEEN THE LIVE TAP AND THE NEW SERVICE TO FACILITATE ADEQUATE PROTECTION OF THE EXISTING WATER MAIN. IT SHOULD BE NOTED THAT THIS TESTING TAKES APPROXIMATELY A WEEK TO COMPLETE AND MUST BE CONDUCTED BY TCWD. A WORK PLAN FOR K) AS A GENERAL PRINCIPAL EACH PROPERTY SHALL HAVE ONE SERVICE AND ONE METER.

A) CATCH BASINS AND DOUBLE CATCH BASINS TO OPSD 705.010 AND 705.020 C/W 600 mm SUMP. REAR LOT CATCH BASINS AND DITCH

B) CATCH BASINS AND DOUBLE CATCH BASINS FRAMES AND GRATES TO OPSD 400.020. REAR LOT CATCH BASIN FRAMES AND GRATES TO OPSD C) CATCH BASIN LEADS - 250 mm DIA. SINGLE AND 300 mm DIA. DOUBLE. CATCH BASIN CONNECTIONS TO OPSD 708.010 AND OPSD 708.030. D) PIPE SUPPORT AT CB'S TO OPSD 708.020. CATCH BASINS AND INLET STRUCTURES FITTED WITH SEDIMENT TRAPS DURING CONSTRUCTION E) HEADWALLS TO BE INSTALLED IN ACCORDANCE WITH OPSD 804.030 (PIPE LESS THAN 900 mm DIA.) OR OPSD 804.040 (AS SPECIFIED), C/W

A) SUBGRADE AND ALL GRANULAR 'A' BOULEVARD MATERIAL TO BE COMPACTED TO A MINIMUM DRY DENSITY OF AT LEAST 95% SPMDD.

C) LIGHT DUTY PAVEMENT TWO LIFTS TOTAL 90mm (50mm HL8 AND 40mm HL3), 150mm GRANULAR 'A', 300mm GRANULAR 'B'. HEAVY DUTY PAVEMENT TWO LIFTS TOTAL 120mm (80mm HL8 AND 40mm HL3), 150 mm GRANULAR 'A', 450mm GRANULAR 'B', ALL

D) CONCRETE SEMI-MOUNTABLE CURB WITH STANDARD GUTTER TO OPSD 600.060 INCLUDING SUPERELEVATED. CONCRETE BARRIER CURB WITH STANDARD GUTTER TO OPSD 600.040. CONCRETE BARRIER CURB TO OPSD 600.110 E) SELECT SUBGRADE MATERIAL, OR IMPORTED GRANULAR MATERIAL APPROVED BY THE ENGINEER, COMPACTED TO 98% S.P.M.D.D. TO BE USED AS FILL IN ALL AREAS WHERE PROPOSED PIPE INVERTS ARE HIGHER THAN EXISTING GRADE OR AS INSTRUCTED BY THE ENGINEER.

F) ALL GRANULARS AND ASPHALT MATERIALS AND PLACEMENT TO BE IN ACCORDANCE WITH OPSS 314 AND OPSS 310 G) JOINTS WITH EXISTING ASPHALT TO BE SAW CUT STRAIGHT PRIOR TO PLACING NEW ASPHALT AND TACK COAT APPLIED TO EXISTING

ASPHALT. ASPHALT JOINT WITH HIGHWAY No. 26 TO BE COMPLETE WITH LAP JOINT, SEE DETAIL THIS PAGE. H) REINSTATEMENT OF ALL DISTURBED BOULEVARDS TO INCLUDE REGRADING, MINIMUM 150mm TOPSOIL AND SOD TO OPSS.MUNI 802 AND 803.

K) SIDEWALKS SHALL BE COMPLETE WITH TACTILE WALKING SURFACE INDICATOR STRIPS, INSTALLED AS PER OPSD 310.039 AND OPSS.MUNI 351.


B) WATER MAIN - DUCTILE IRON CLASS 52, OR PRESSURE CLASS 350 CEMENT LINED. CONDUCTIVITY CONNECTORS TO BE USED ON ALL JOINTS. D) VALVES - RESILIENT SEATED, RSGV, MECHANICAL JOINT, OPEN LEFT CLOW OR MUELLER WITH 5 SL-48 SLIDING VALVE BOX, TO AWWA C504.

F) RESTRAINER - ROMAC GRIPPER RING FOR PIPE SIZES UP TO 300 mm AND SIGMA ONE-LOCK FOR PIPE SIZES GREATER THAN 300 mm.

J) PERFORATED SUBDRAINS – 100mm DIA. BIG 'O' WITH GEOTEXTILE FILTER SOCK OR APPROVED EQUAL UNLESS NOTED OTHERWISE.

TOWN APPROVAL

SH ESTATES	TATHAM			
	DESIGN: K G/SBU	FILE: 120181	DWG:	
NOTES	DRAWN: KH/SBU	DATE: NOV 2021	DE-1	
	CHECK: DC	SCALE: 1:500		

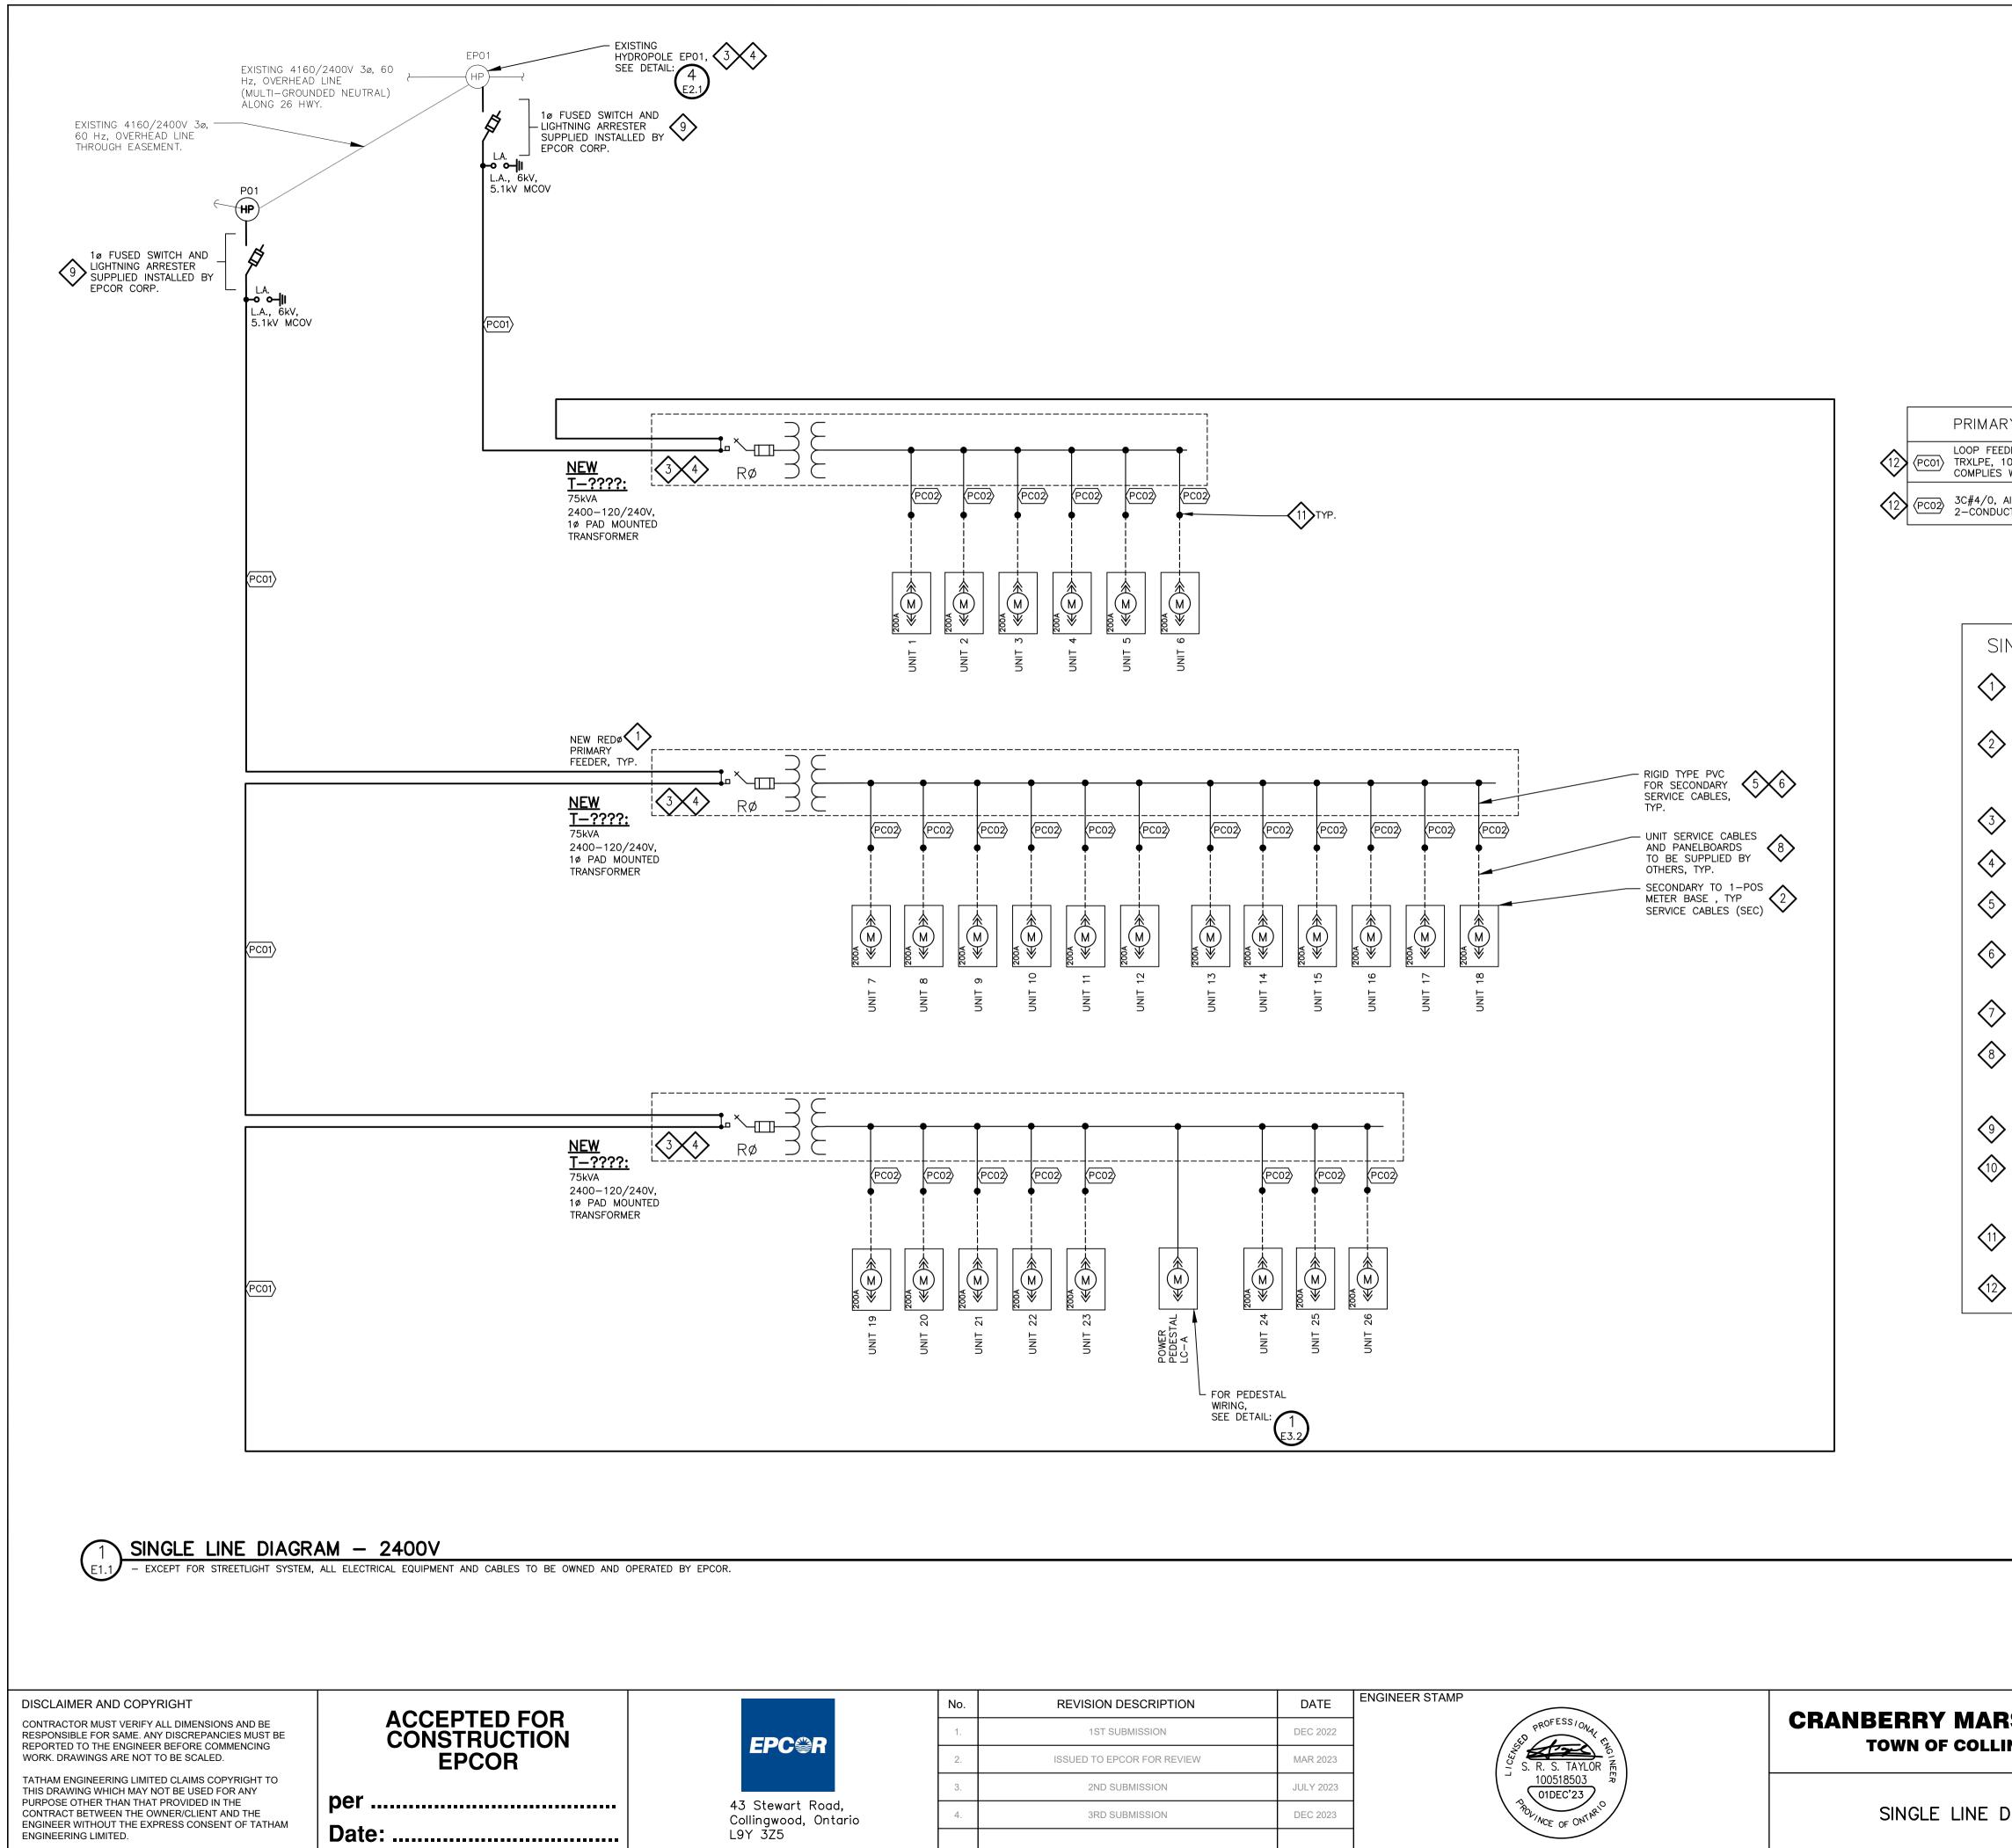


RY CABLE DESCRIPTION	INSTALLATION
EDER: 1C#1/0 AWG Cu CLASS B STRANDED, 15kV RATED, 100% CONCENTRIC NEUTRAL, IN UNDERGROUND DUCTBANK, 5 WITH CSA C68.3, LATEST ISSUE.	1–103mmø TYPE DB2 DIRECT BURIED DUCT(S) WITH SAND BEDDING ALL AROUND.
AI, TYPE USEI90, CLASS 'B' STRANDED, 600V RATED, JCTOR + 100% NEUTRAL, XLPE INSULATION PVC JACKET	1–103mmø TYPE DB2 DIRECT BURIED DUCT(S) WITH SAND BEDDING ALL AROUND.

SINGLE LINE DIAGRAM NOTES: PC01: PRIMARY LOOP FEEDER CABLE: 1C#1/0AWG IN 103mmø PVC DUCT. REFER TO EPCOR'S "GENERAL CONTRACTOR REQUIREMENTS AND MATERIAL SPECIFICATIONS" FOR PRIMARY CABLE SPECIFICATIONS FOR PRIMARY CABLE SPECIFICATIONS. 1-POSITION 200A RATED METER BASE: HYDEL ENTERPRISES EK400RO SERIES, THOMAS AND BETTS MICROELECTRIC BS2-TCV, EATON CULTER-HAMMER LM2 120 AMP, LINE/LOAD CABLES UP TO 250MCM CU/AL, WEATHERPROOF RATED (EEMAC 3R). REFER TO EPCOR'S "GENERAL CONTRACTOR REQUIREMENTS AND MATERIAL SPECIFICATIONS". SEPCOR TO SUPPLY AND INSTALL NEW TRANSFORMER. CONTRACTOR TO PROVIDE CONCRETE VAULT AND GROUNDING GRID. PER EPCOR STANARDS. ALL PRIMARY AND SECONDARY CABLE TERMINATIONS INS AND AT HYDRO POLES WILL BE PERFORMED BY EPCOR. ALL PRIMARY AND SECONDARY CABLE TERMINATIONS INSIDE EACH TRANSFORMER EXPOSED SECTIONS OF CONDUIT (ABOVE GRADE) FOR SECONDARY FEEDER CABLES MUST BE RIGID PVC. 6 POC2: SECONDARY SERVICE CABLES FOR 1-POSITION 200A METER BASES: 3C#4/0AWG AI. USEI90. REFER TO EPCOR'S "GENERAL CONTRACTOR REQUIREMENTS AND MATERIAL SPECIFICATIONS" FOR SECONDARY CARLE OFFICIENTS AND MATERIAL SPECIFICATIONS" FOR SECONDARY CABLE SPECIFICATIONS. TYPICAL FOR TOWNHOUSE UNITS WITH 200A SERVICE MAXIMUM ELECTRICAL SERVICES TO EACH UNIT: 200AMP MAX., 120/240VAC, 1-PHASE, 60HZ. SERVICE CABLES TO ENTER UNIT (VIA UNDERGROUND) BY OTHERS DURING THIS CONTRACT. CONTRACTOR TO COORDINATE LOCATION OF METERS WITH CONTRACTOR INSTALLING UNIT PANELBOARDS PRIOR TO INSTALLING SERVICE CABLES TO METER BASES. EPCOR TO RE-FRAME EXISTING EP01 HYDRO POLE TO ACCOMIDATE NEW 1Ø PRIMARY RISER. CONTRACTOR TO PROVIDE 20m OF ADDITIONAL PRIMARY CABLE AT BASE OF POLE, INCLUDES CONDUITS AND CABLE GUARDS AT POLE FOR PRIMARY RISER. EPCOR TO COMPLETE TERMINATIONS OF PRIMARY CABLES ALL WORK TO BE DONE TO COMPLETE TERMINATIONS OF PRIMARY CABLES. ALL WORK TO BE DONE TO EPCORS STANDARDS. TERMINATE SECONDARY ELECTRICAL SERVICE AT LOT LINE ON DRIVEWAY SIDE OF


LOT PER EPCOR STANDARDS. SECURE 1m OF SECONDARY CABLE TO 2" X 4" X 8' WOOD MARKER STAKE. SECONDARY SPLICE AND CONNECTION TO METER BASE BY OTHERS. COORDINATE DRIVEWAY AND METER BASE LOCATIONS WITH DEVELOPER.

REFER TO EPCOR GENERAL CONTRACTOR INFORMATION, AS PROVIDED ON THEIR WEBPAGE: www.epcor.com


RSH ESTATES			
	DESIGN: RJW	FILE: 120181	DWG:
DIAGRAM	DRAWN: RJW	DATE: OCT 2021	E1.1
	CHECK: SRT	SCALE: AS SHOWN	

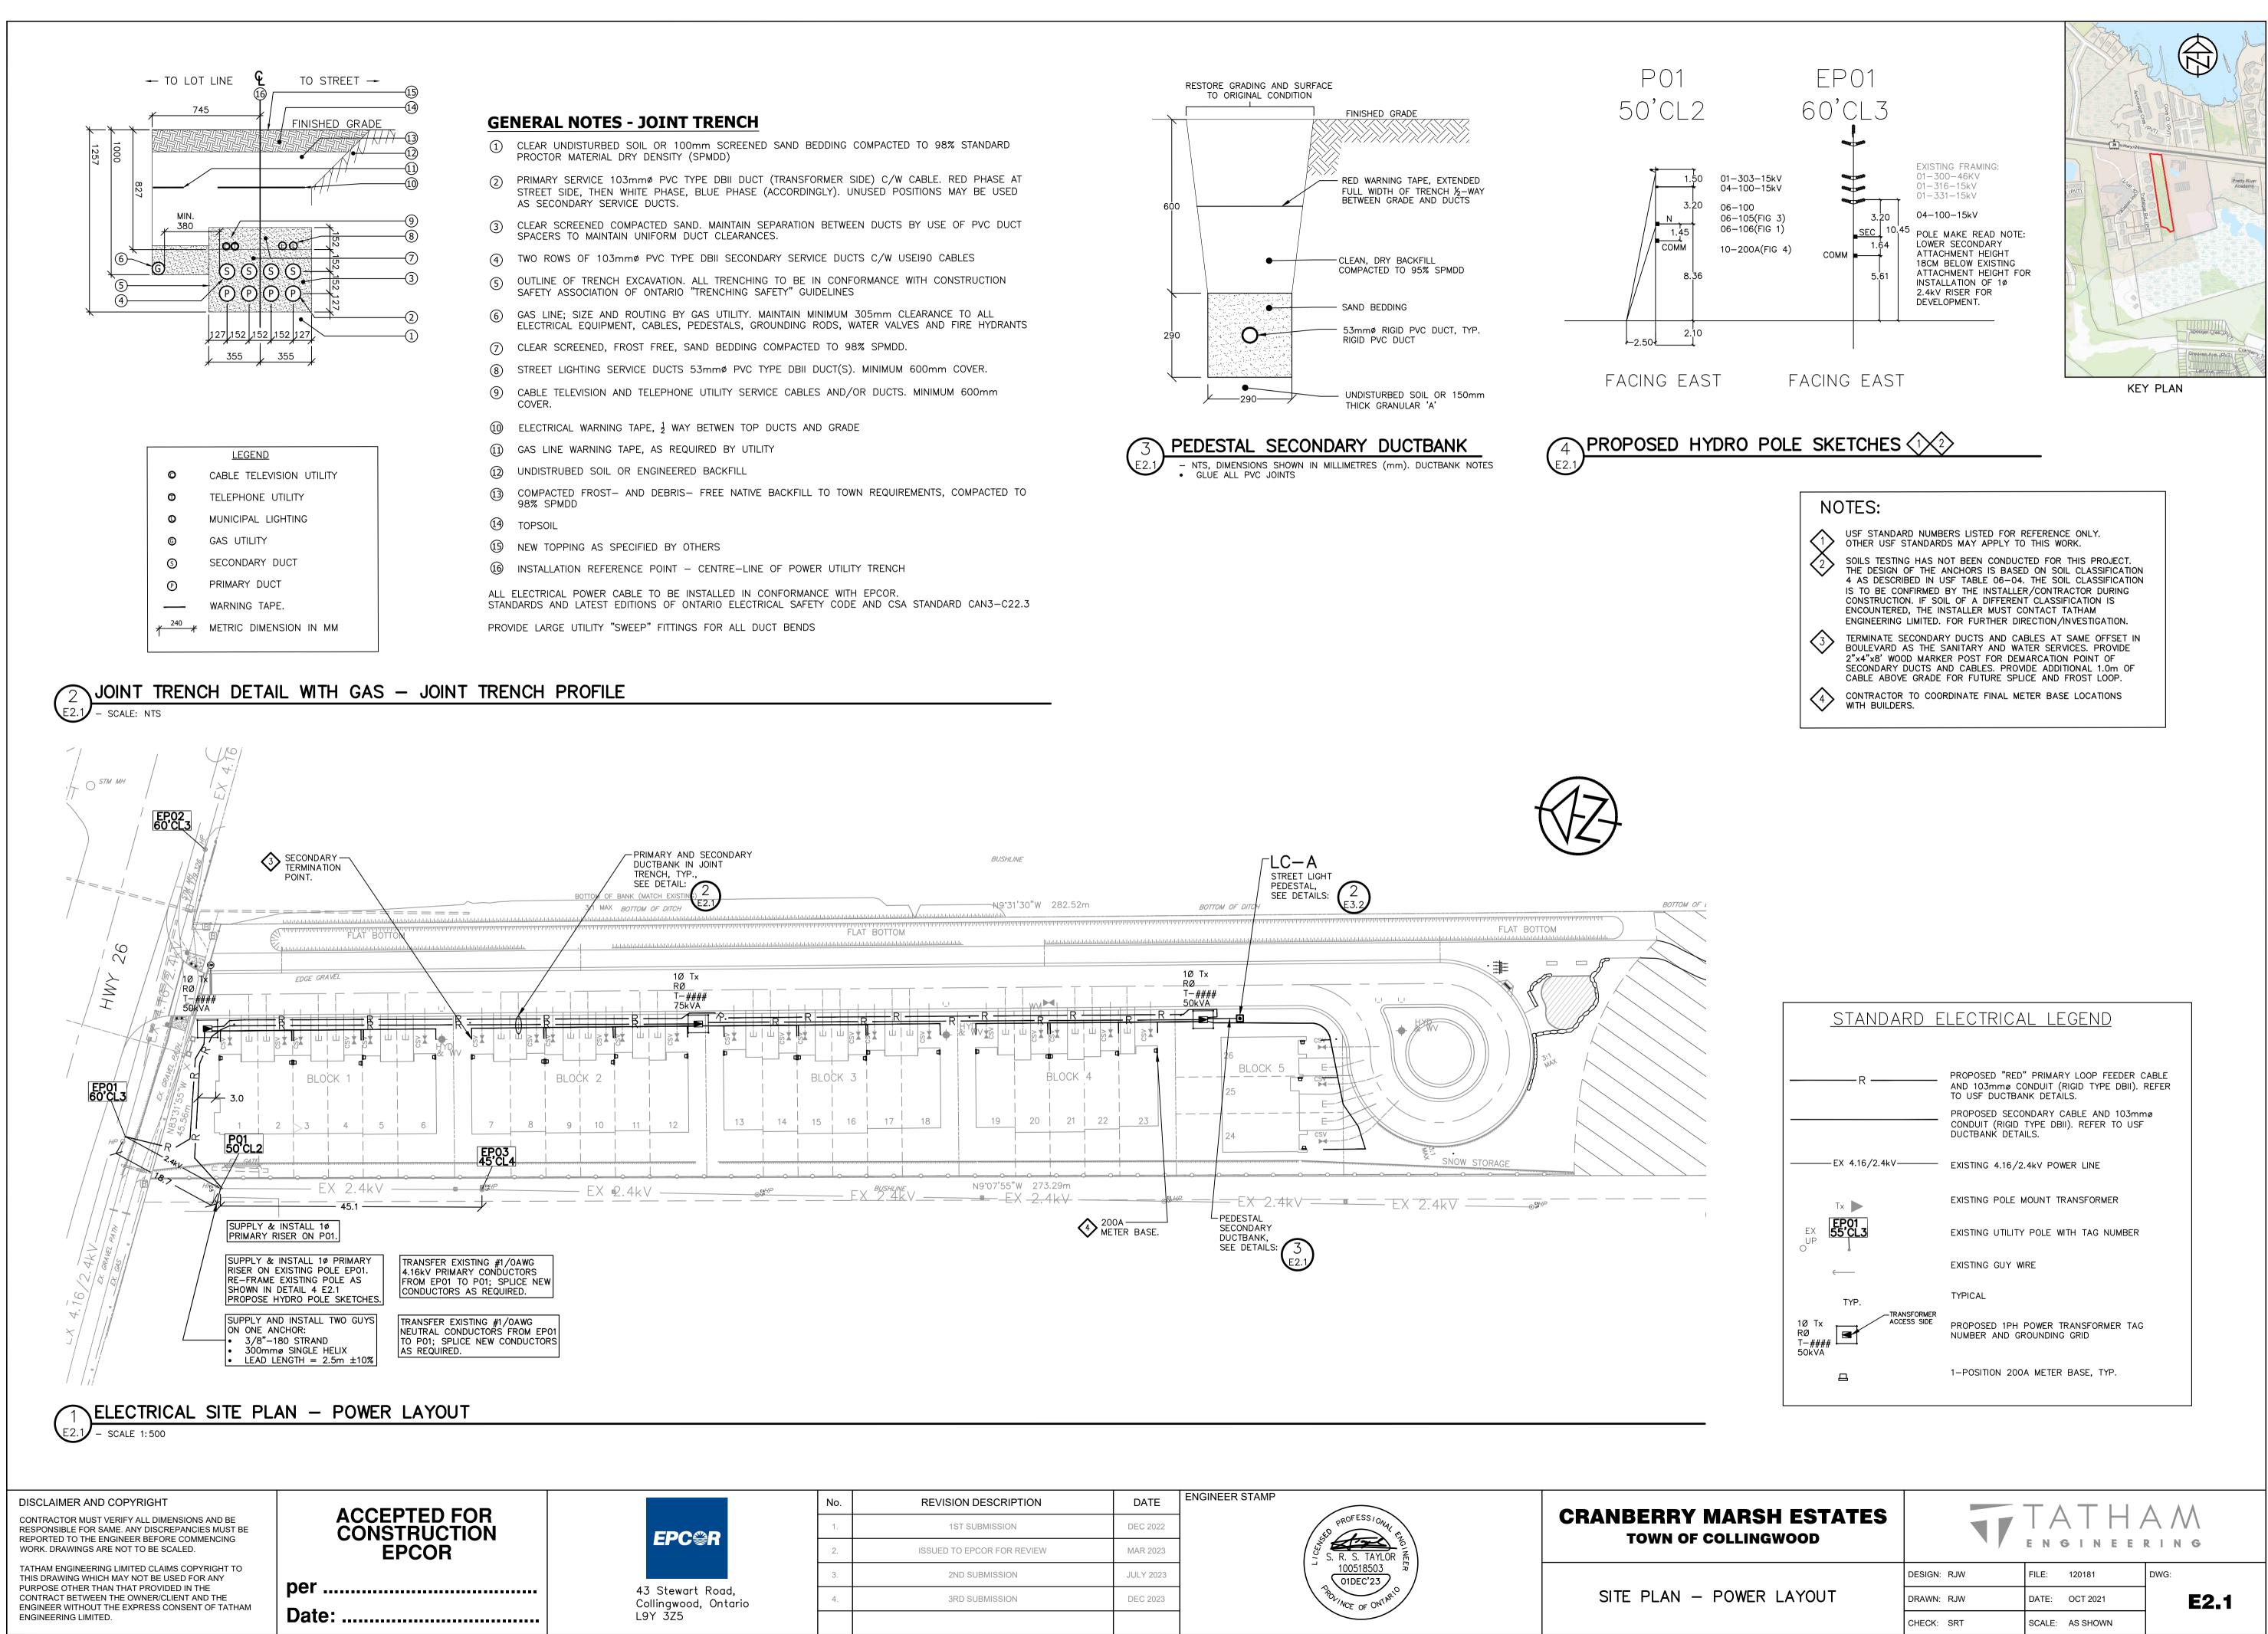

No.	REVISION DESCRIPTION	DATE	ENGINEER STAMP				^ ^ ^
1.	1ST SUBMISSION	DEC 2022	PROFESS/ONAL PR	CRANBERRY MARSH ESTATES TOWN OF COLLINGWOOD		IAIH	AM
2.	ISSUED TO EPCOR FOR REVIEW	MAR 2023	S. R. S. TAYLOR			ENGINEE	RING
3.	2ND SUBMISSION	JULY 2023	$\left[\begin{array}{c} 100518503 \\ 01DEC'23 \end{array} \right]$		DESIGN: RJW	FILE: 120181	DWG:
4.	3RD SUBMISSION	DEC 2023	POLINCE OF ONT AR	SITE PLAN – POWER LAYOUT	DRAWN: RJW	DATE: OCT 2021	E2.1
					CHECK: SRT	SCALE: AS SHOWN	

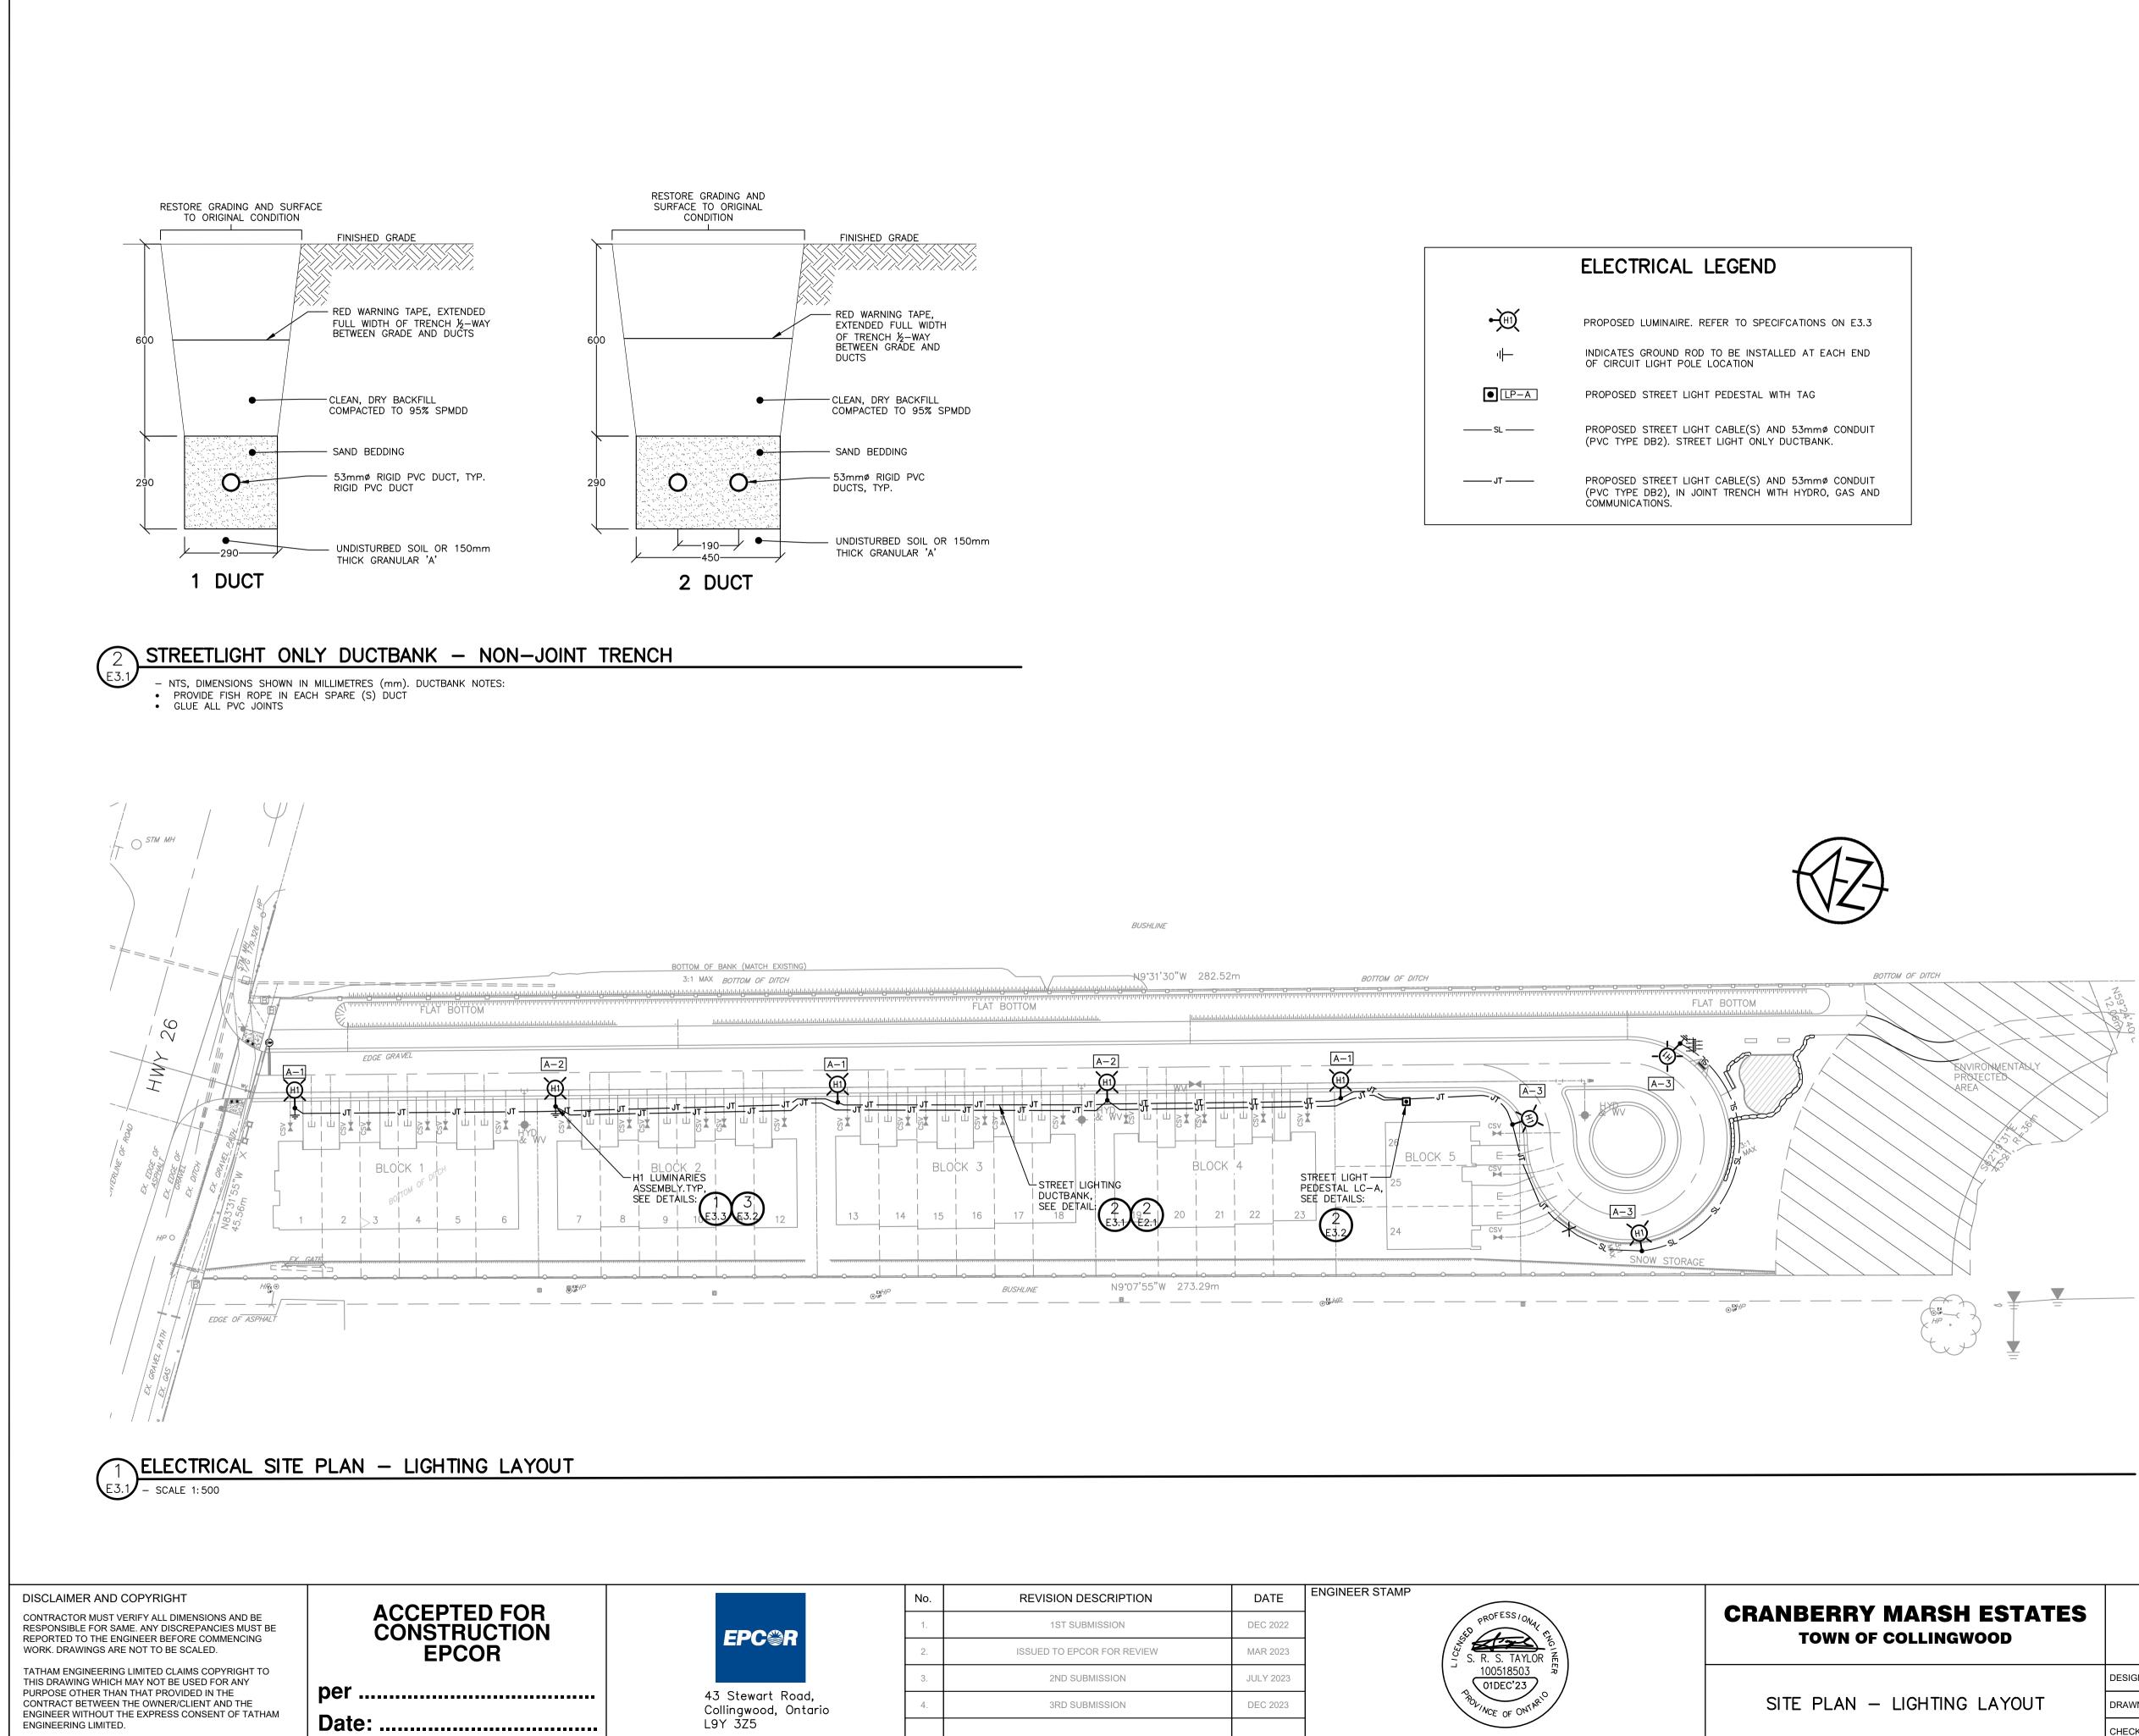


	ELECTRICAL LEGEND
	PROPOSED LUMINAIRE. REFER TO SPECIFCATIONS ON E3.3
	INDICATES GROUND ROD TO BE INSTALLED AT EACH END OF CIRCUIT LIGHT POLE LOCATION
• LP-A	PROPOSED STREET LIGHT PEDESTAL WITH TAG
SL	PROPOSED STREET LIGHT CABLE(S) AND 53mmø CONDUIT (PVC TYPE DB2). STREET LIGHT ONLY DUCTBANK.
JT	PROPOSED STREET LIGHT CABLE(S) AND 53mmø CONDUIT (PVC TYPE DB2), IN JOINT TRENCH WITH HYDRO, GAS AND COMMUNICATIONS.

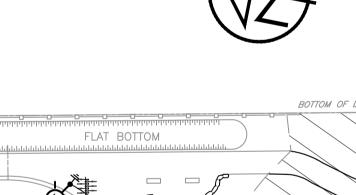

No.	REVISION DESCRIPTION	DATE	ENGINEER STAMP				^ ^ ^
1.	1ST SUBMISSION	DEC 2022	PROFESSION AL	CRANBERRY MARSH ESTATES TOWN OF COLLINGWOOD		IAIH	A/M
2.	ISSUED TO EPCOR FOR REVIEW	MAR 2023	S. R. S. TAYLOR			ENGINEE	RING
3.	2ND SUBMISSION	JULY 2023	100518503 5 () () () () () () () () () () () () ()		DESIGN: RJW	FILE: 120181	DWG:
4.	3RD SUBMISSION	DEC 2023	ROLINCE OF ONTARIO	SITE PLAN - LIGHTING LAYOUT	DRAWN: RJW	DATE: OCT 2021	E3.1
					CHECK: SRT	SCALE: AS SHOWN	






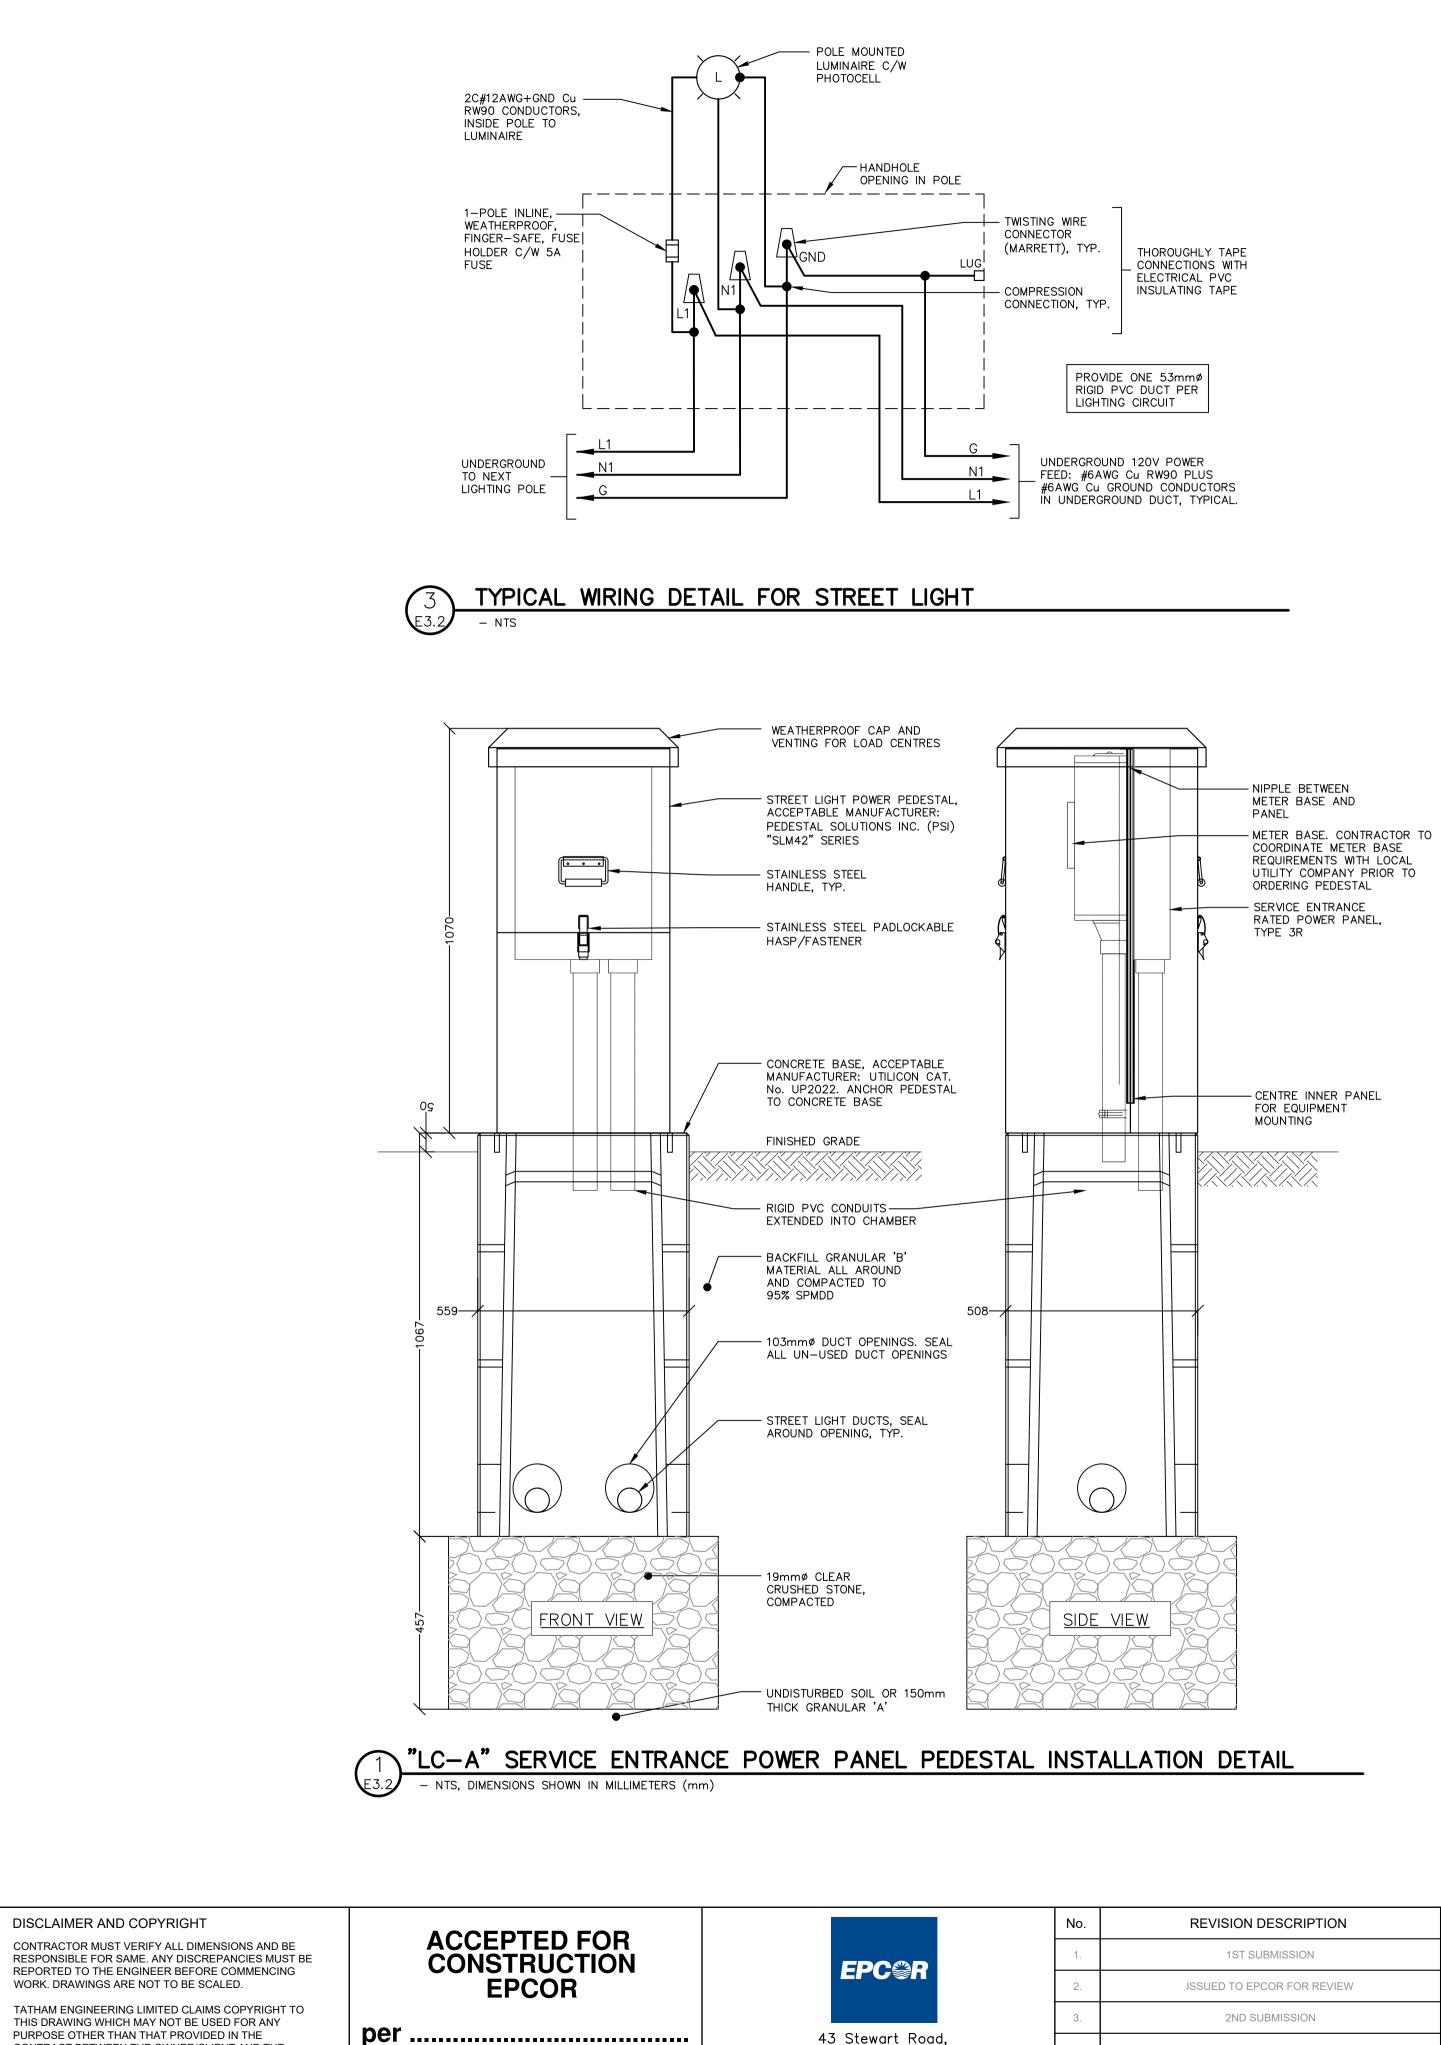


PURPOSE OTHER THAN THAT PROVIDED IN THE CONTRACT BETWEEN THE OWNER/CLIENT AND THE ENGINEER WITHOUT THE EXPRESS CONSENT OF TATHAM ENGINEERING LIMITED.

Date:


43 Stewart Road, Collingwood, Ontario L9Y 3Z5

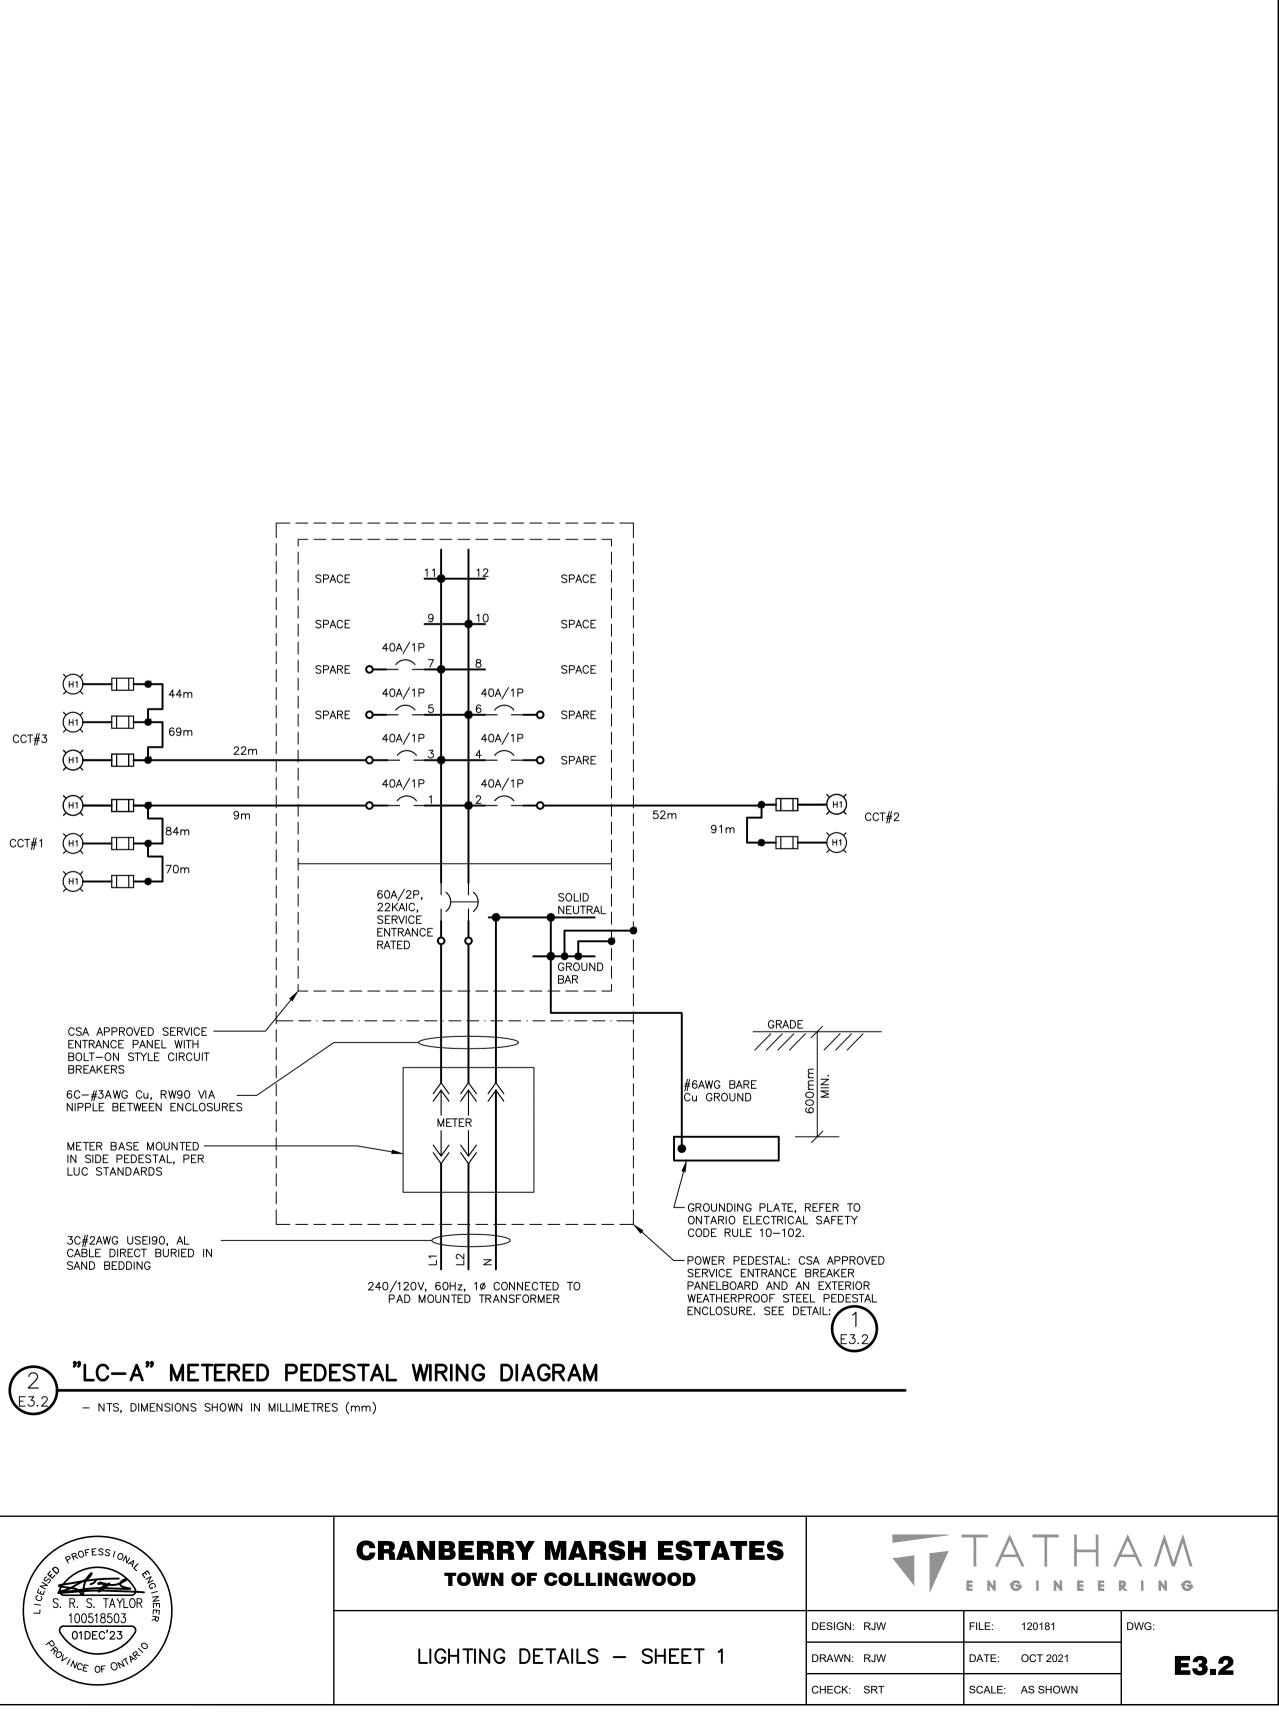

No.	REVISION DESCRIPTION	DATE
1.	1ST SUBMISSION	DEC 2022
2.	ISSUED TO EPCOR FOR REVIEW	MAR 2023
3.	2ND SUBMISSION	JULY 2023
4.	3RD SUBMISSION	DEC 2023

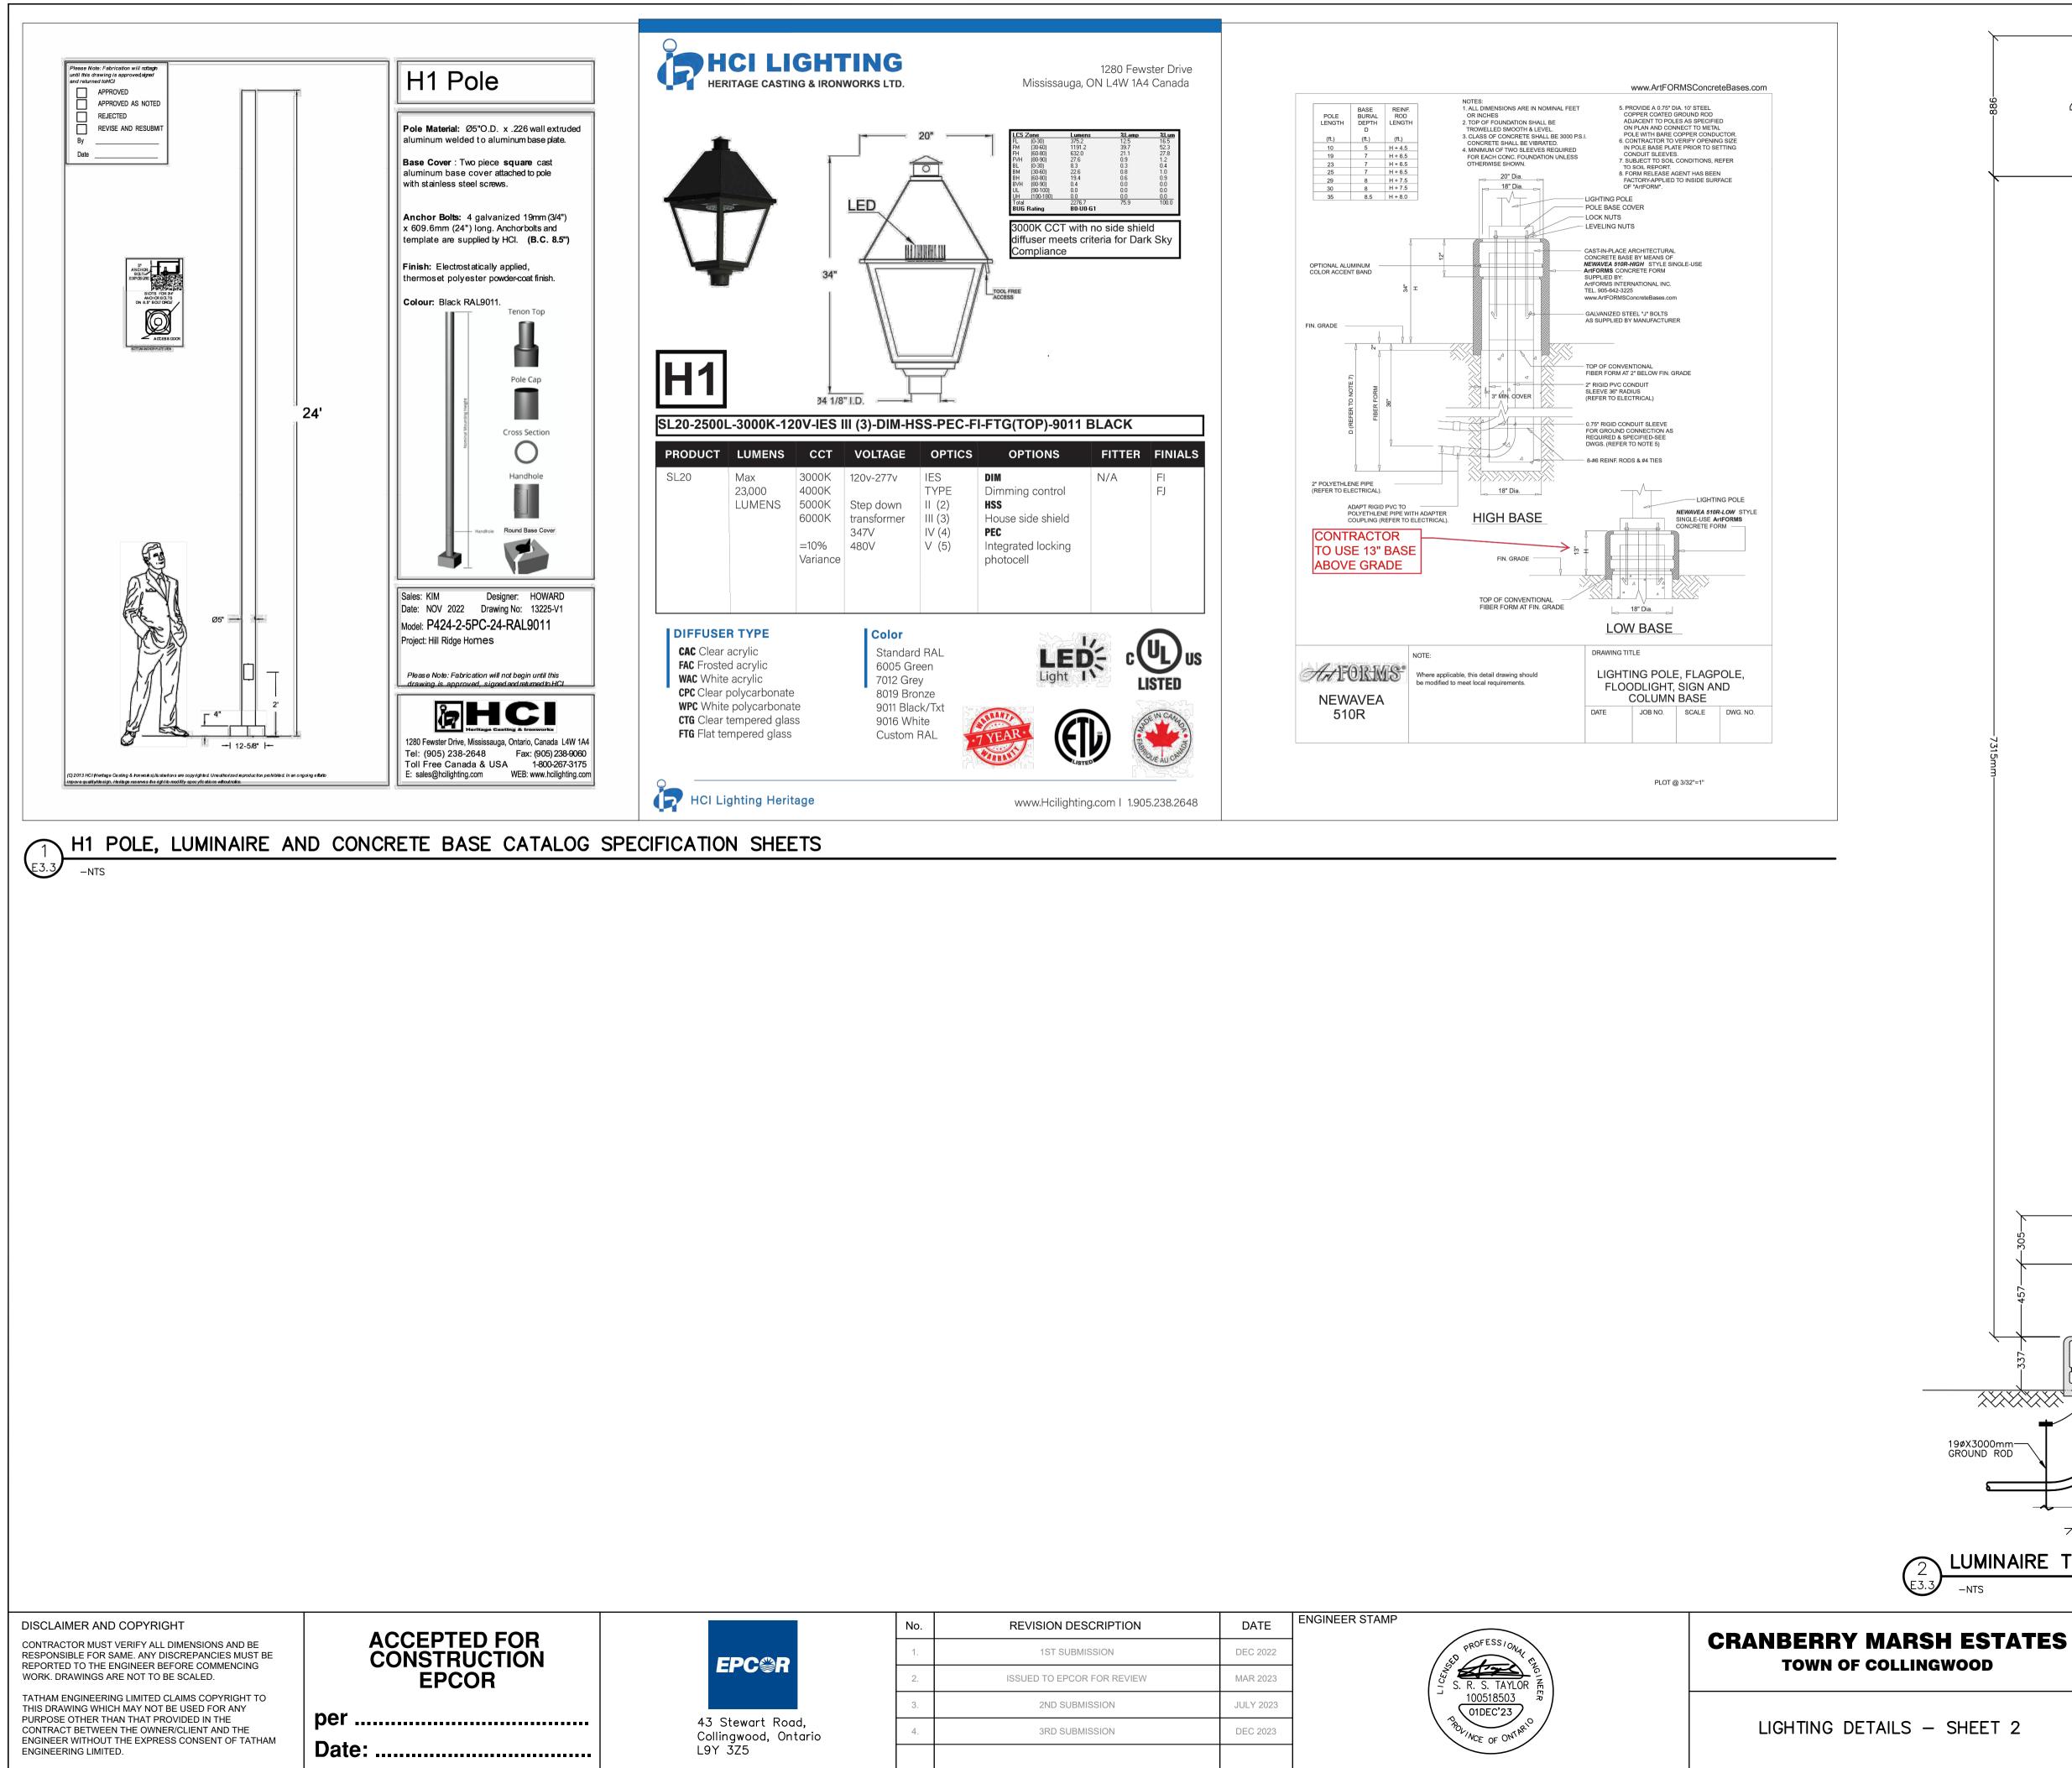

NO.	REVISION DESCRIPTION	DATE
1.	1ST SUBMISSION	DEC 2022
2.	ISSUED TO EPCOR FOR REVIEW	MAR 2023
3.	2ND SUBMISSION	JULY 2023
4.	3RD SUBMISSION	DEC 2023

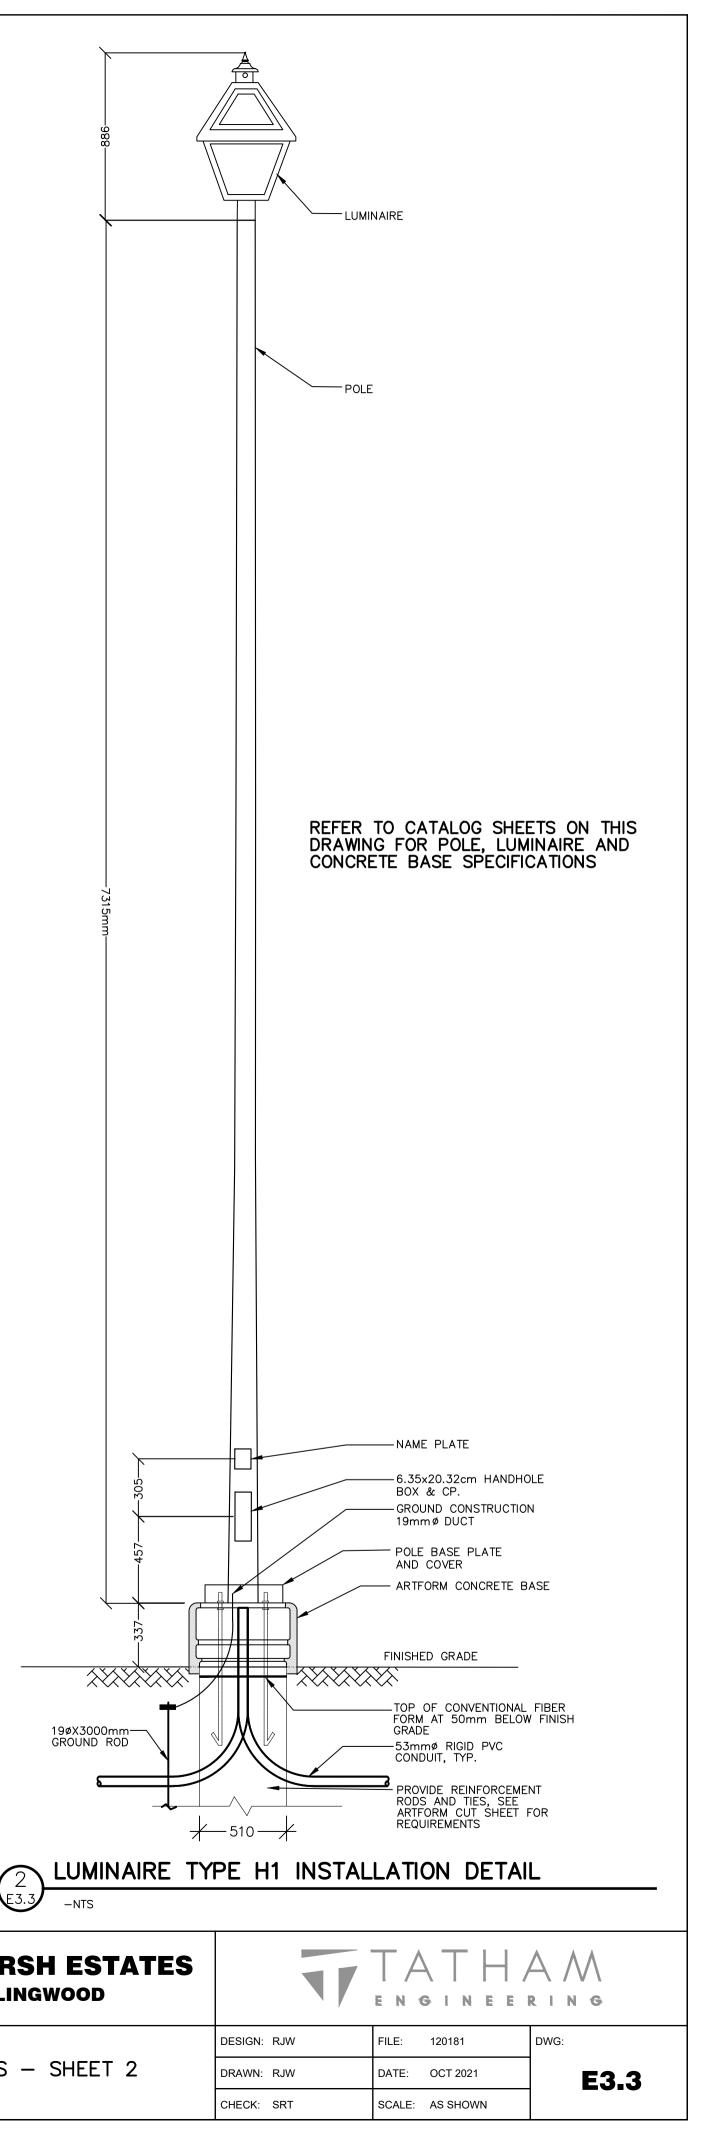

. E 4 4 4 4 4 4 4 4 4 4 4 4 4 4 4 4 4 4

Calculation Summary						
Label	CalcType	Units	Avg	Max	Min	Avg/M
01-RW- Roadway	Illuminance	Lux	5.06	15.2	0.8	6.33
07-PA-Pathway	Illuminance	Lux	2.01	9.1	1.0	2.01
08-CU-Culdesac	Illuminance	Lux	6.06	15.0	0.7	8.66
09-TP-Property Line	Illuminance	Lux	0.00	0.0	0.0	N.A.

E4.1 -NTS


					l
	METRI	C LUMINAIRE S	SCHEDULE		
E4.1 -NTS REFER TO DR	AWING E3.	3 FOR DETAILED POLE AND	LUMINAIRE SPECIFICATIONS		

Luminai	re Scl	hedule						
Symbol		Qty	Label	Arrangement	Description	LLF	Luminaire Lumens	Luminaire Watts
•	D)	8	Н1	Single	HCI-SL20 Series	0.950	2500	20


Table 11-1: Lighting Design Criter	<u>ia for Streets</u>	<u>Table 11-2: Recommended Design</u> Walkways Within Road Right of Wa		Table 17-2. Recommended Mainta Illuminance Values for Parking Lot	
Road: Pedestrian Conflict Area: Pavement Classification:	Local Low R3	Condition: Average Illuminance Values: Uniformity Ratio Max (Avg/Min):	Low Pedestrian Activity 2.0 Lux 5.0:1	basic requirements; not for secur	<u>ity lighting</u>
Average Luminance Values: Average Illuminance Values: Uniformity Ratio Max (Avg/Min):	0.3 cd/sq. m 4.5 Lux 6.0:1 (MAX.)	onnormity Ratio Max (Avg/Min).	5.0.1	Minimum Illuminance Values: Uniformity Ratio Max (Max/Min):	2.0 Lux 20.0:1




E4.1 IES RP8-21 TARGET VALUES

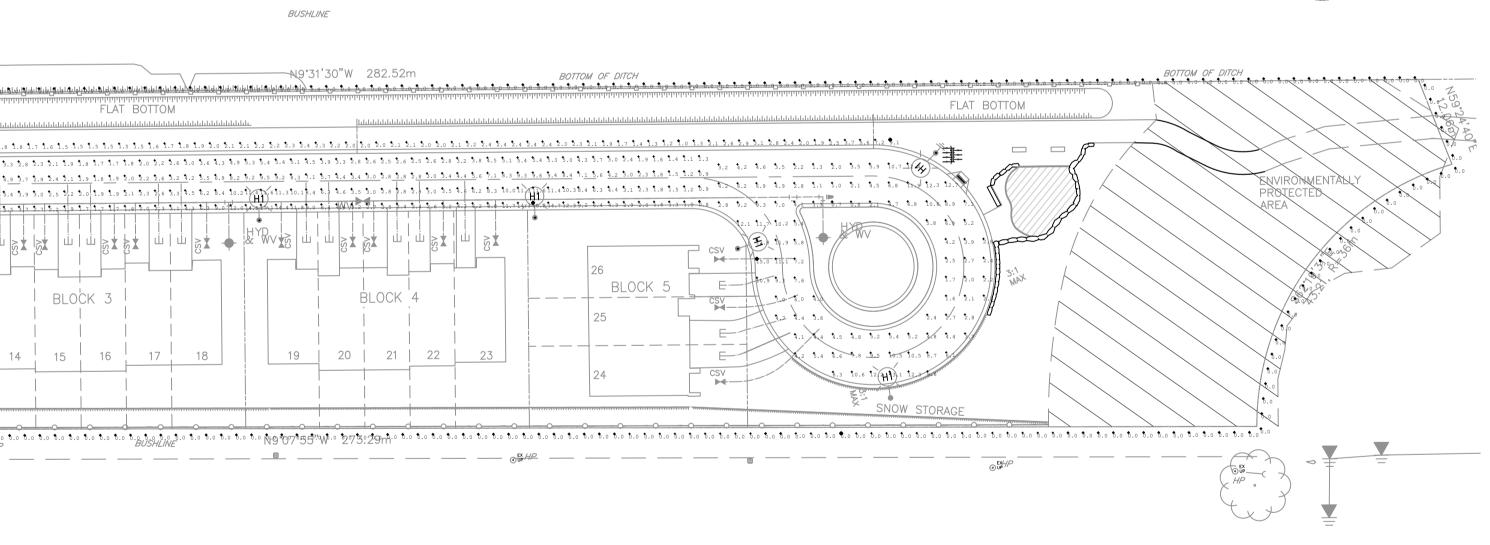


No.	REVISION DESCRIPTION	DATE	ENGINEER STAMP				~ ~ ~
1.	1ST SUBMISSION	DEC 2022	PROFESS/ONAR	CRANBERRY MARSH ESTATES TOWN OF COLLINGWOOD		IAIH	A/V
2.	ISSUED TO EPCOR FOR REVIEW	MAR 2023	S. R. S. TAYLOR			ENGINEE	RING
3.	2ND SUBMISSION	JULY 2023	$\left(\begin{array}{c} 100518503 \\ 01DEC^{2}23 \end{array} \right)^{\frac{1}{2}} \right)$		DESIGN: RJW	FILE: 120181	DWG:
4.	3RD SUBMISSION	DEC 2023	ROLINCE OF ONTARIO	SITE PLAN - PHOTOMETRIC LAYOUT	DRAWN: RJW	DATE: OCT 2021	E4.1
					CHECK: SRT	SCALE: AS SHOWN	

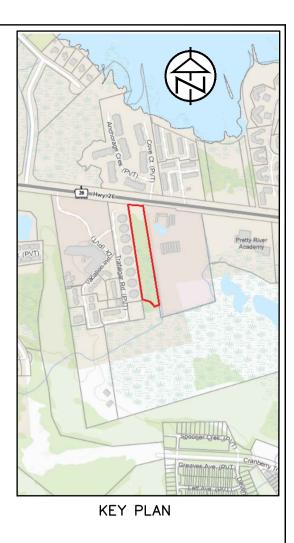



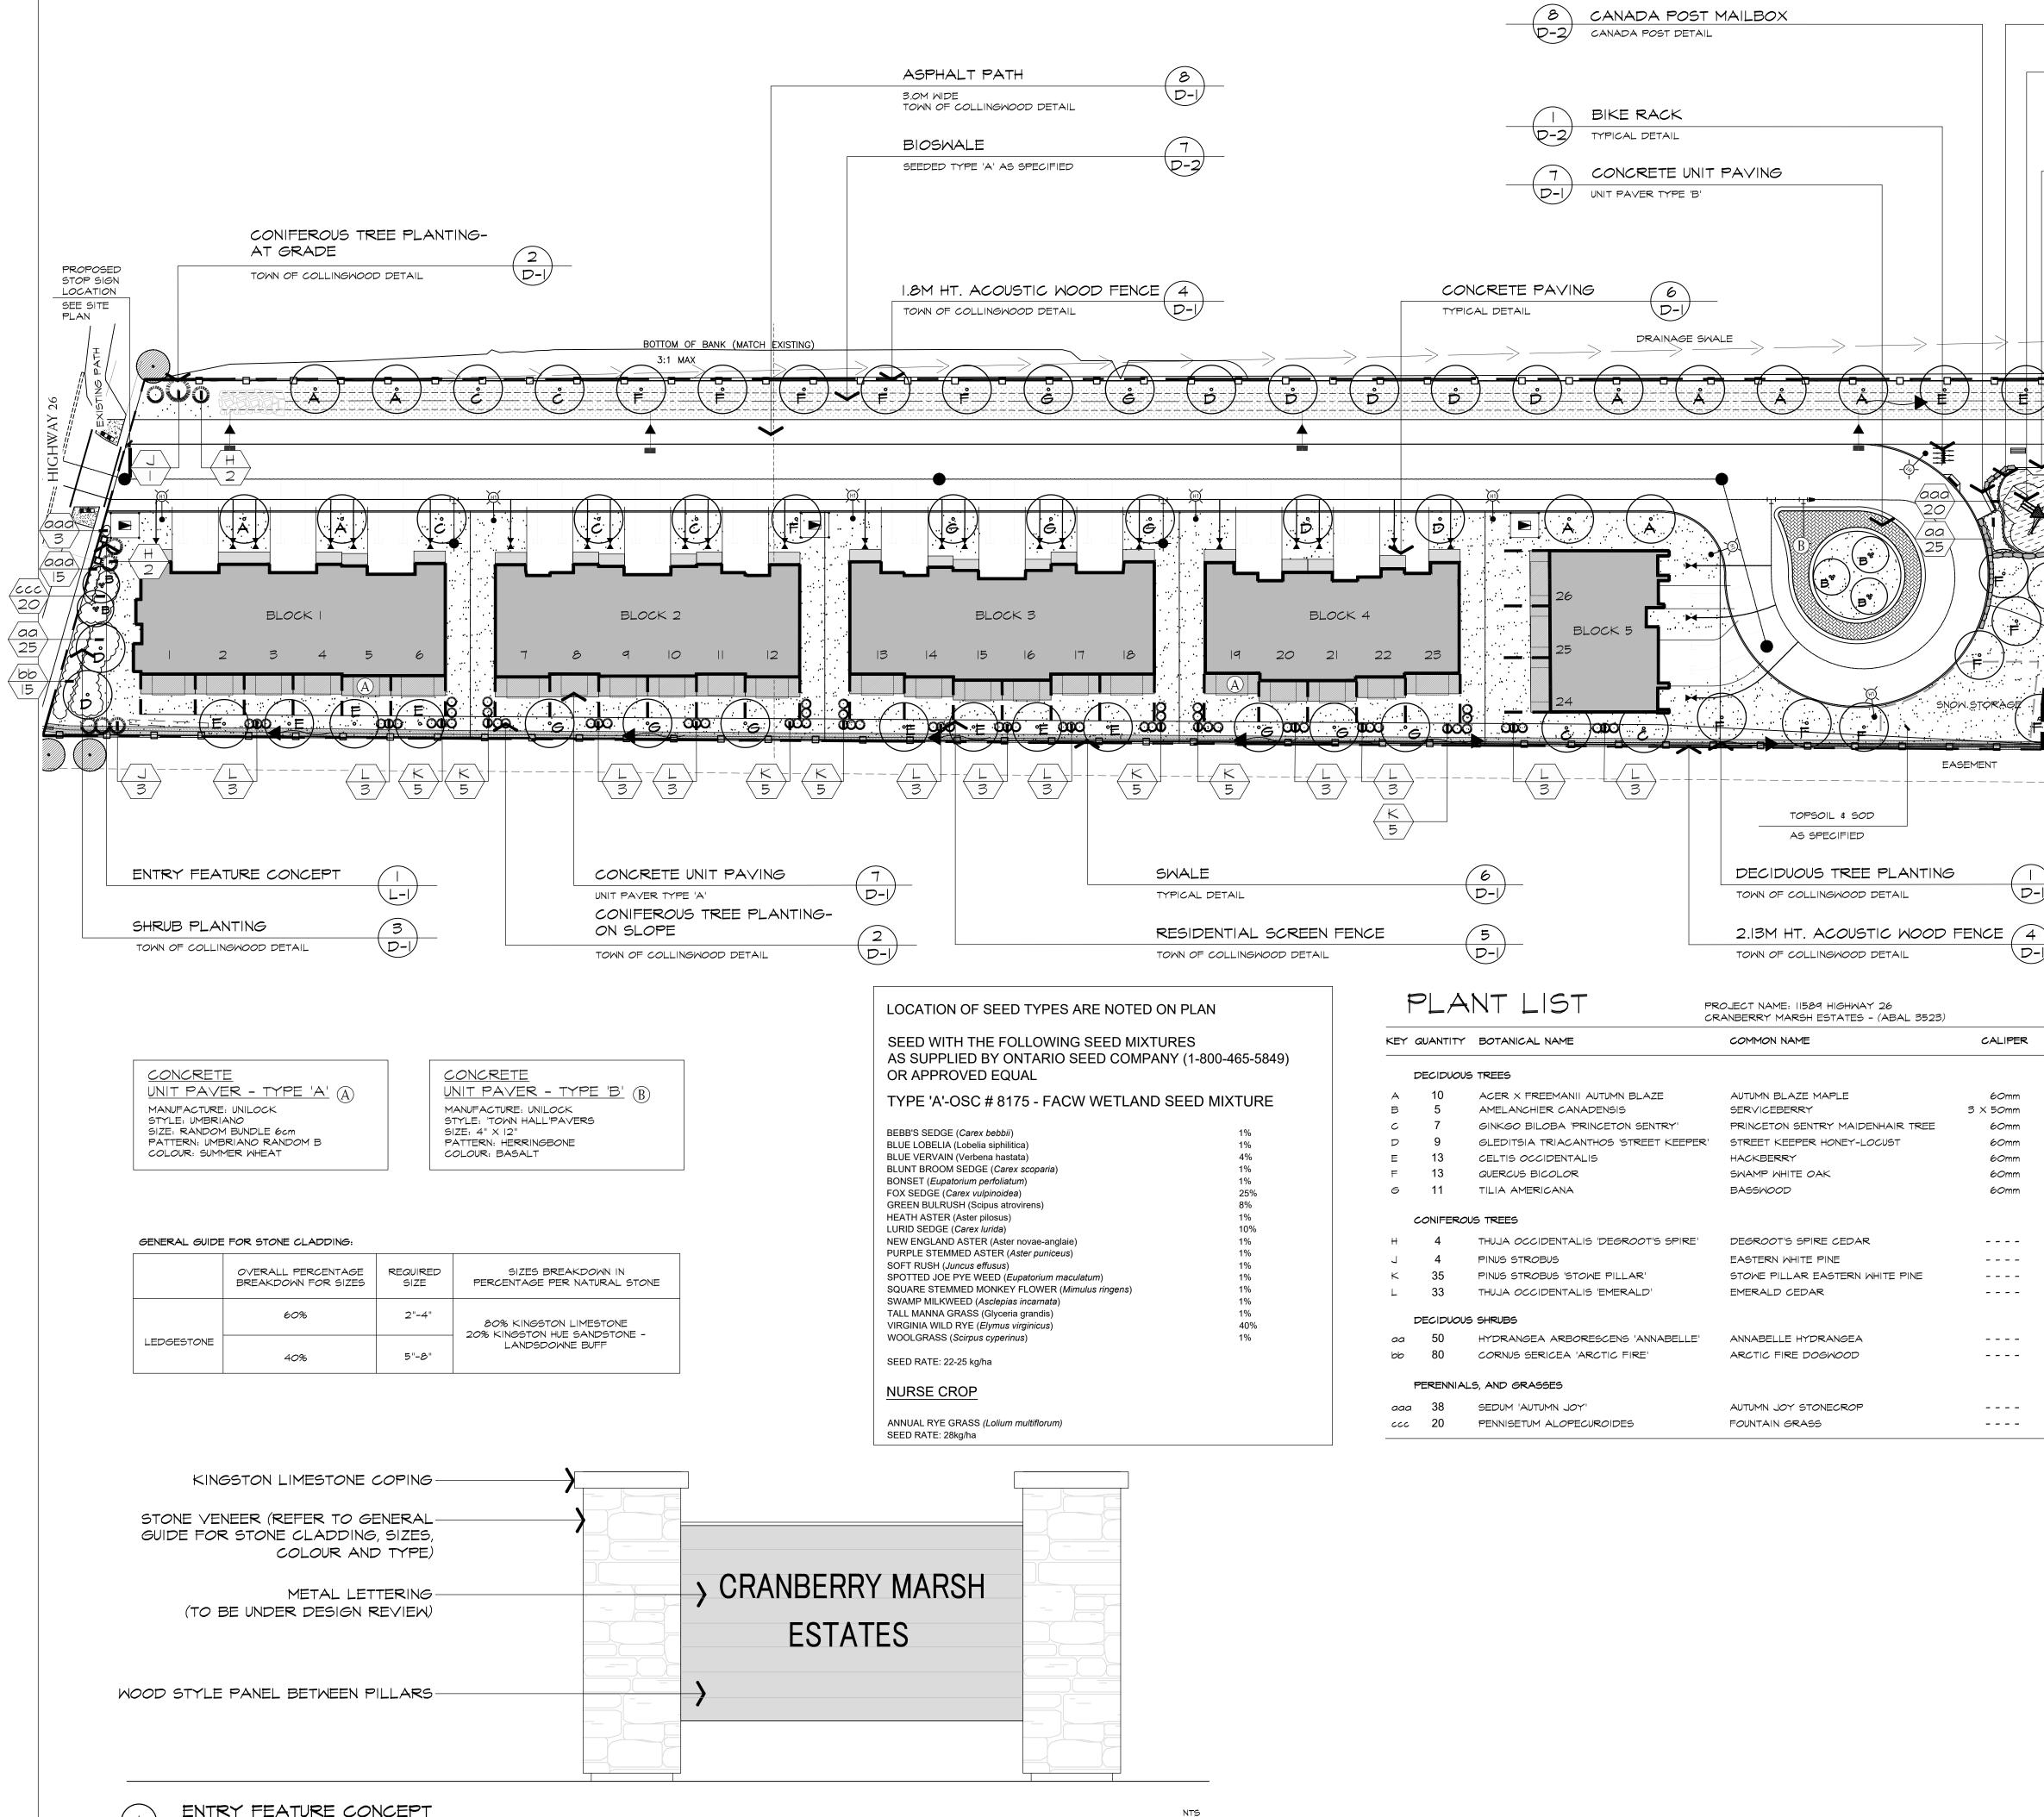

NOTE: CONTRACTOR RESPONSIBLE FOR PROVIDING SHOP DRAWINGS STAMPED BY A STRUCTURAL ENGINEER FOR FINAL APPROVAL BY LANDSCAPE ARCHITECT. STRUCTURAL WORKS TO BE REVIEWED AND CERTIFIED BY THE DESIGN ENGINEER.

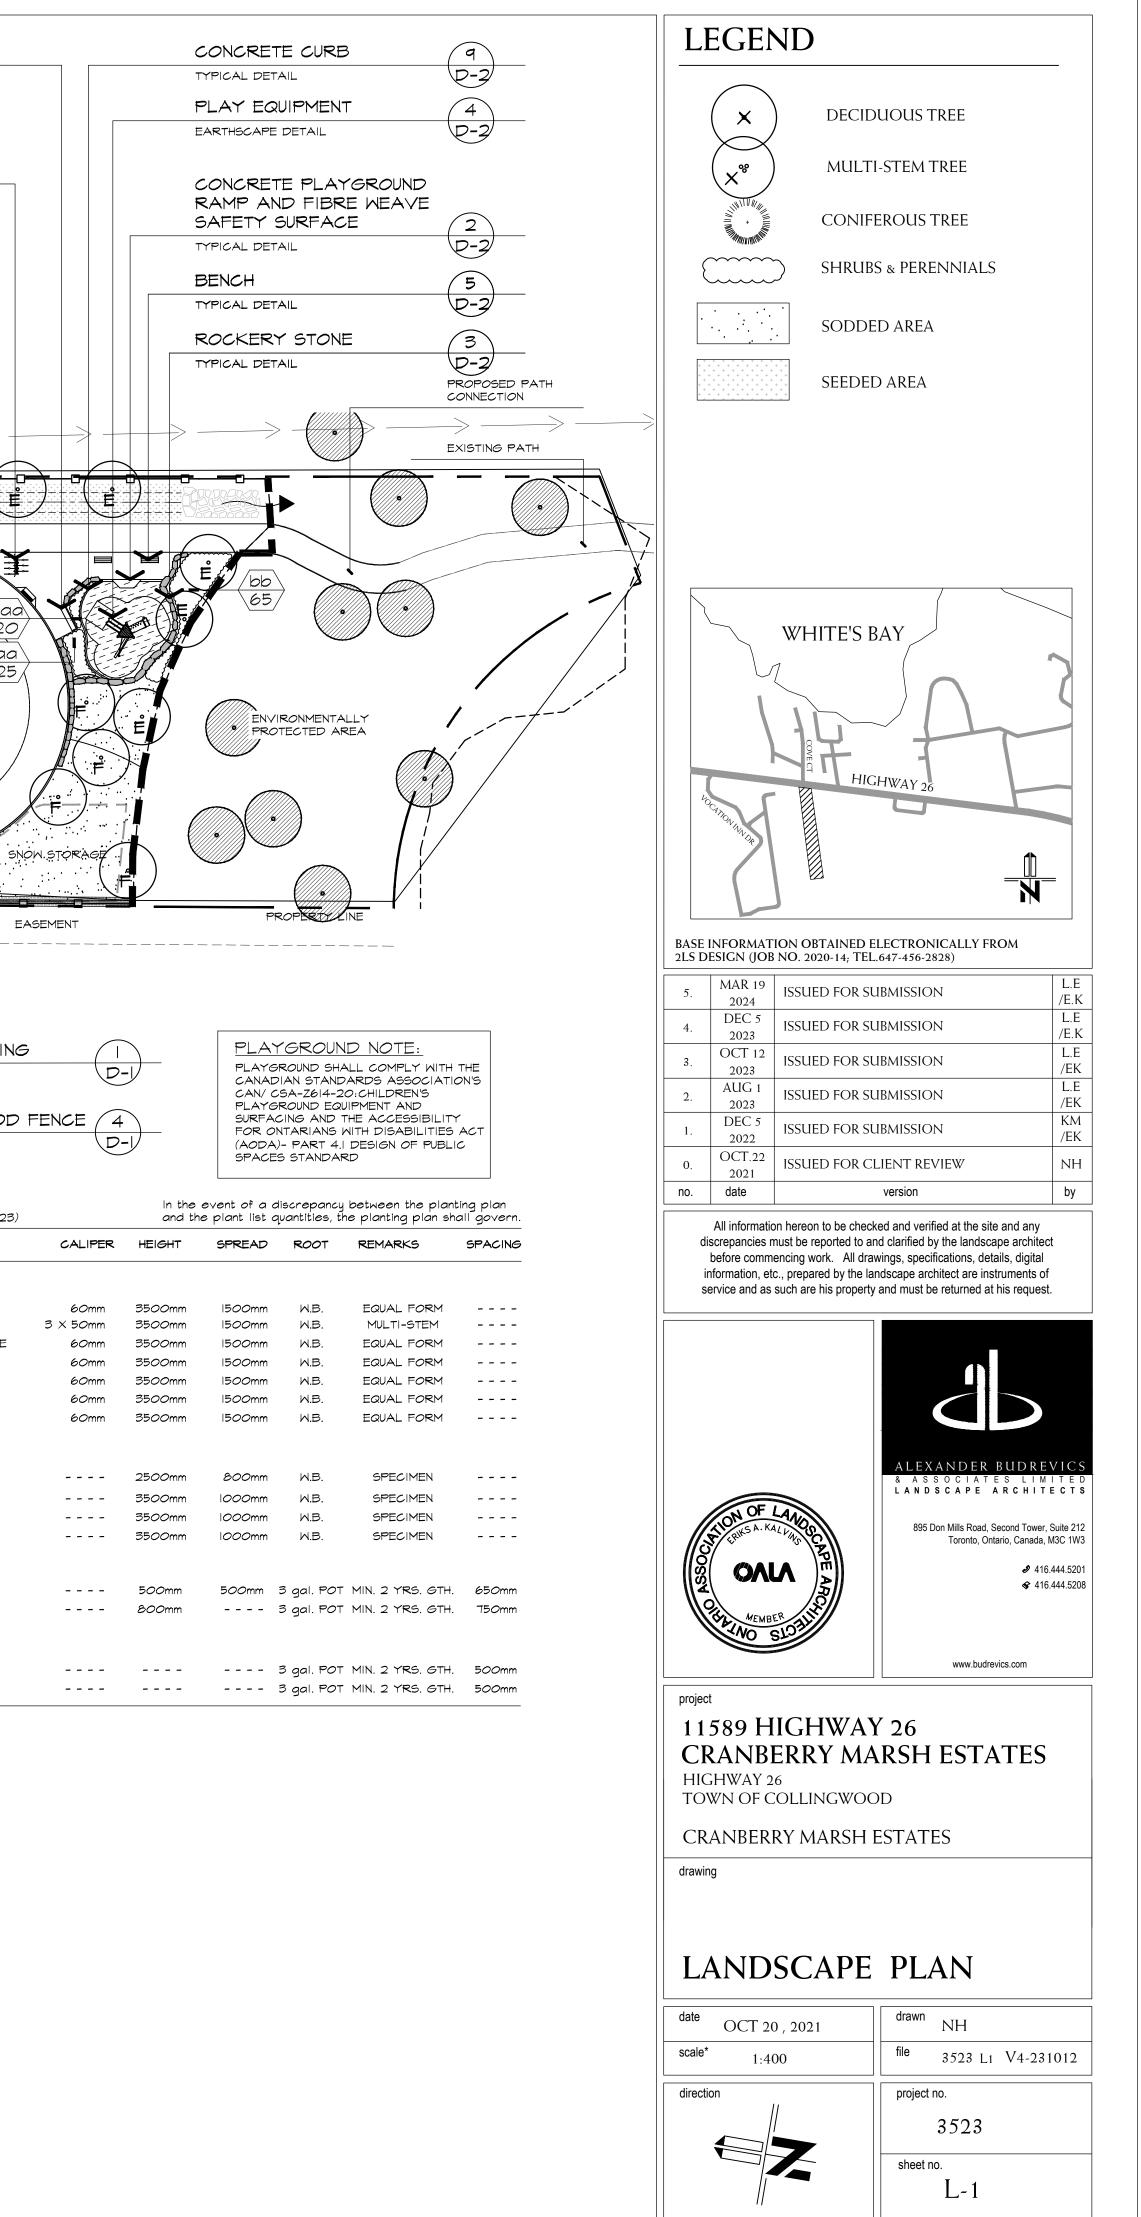

*NOTED SCALE IS APPLICABLE ONLY WHEN PRINTED ON ARCH D (24"x36") SIZE SHEET

SPECIFICATIONS

SOFT LANDSCAPING

ALL PLANTS SHALL BE NURSERY GROWN.

PLANT MATERIALS

BED PREPARATION

TOPSOIL & FINE GRADING

SODDING

ASSOCIATION.

GENERAL

THESE SPECIFICATIONS ARE TO BE READ IN CONJUNCTION WITH THE GENERAL CONDITIONS OF THE CONTRACT AS PREPARED BY AND AVAILABLE AT THE OFFICE OF ALEXANDER BUDREVICS & ASSOCIATES LTD.

HARD LANDSCAPING

WOODWORK

STAIN, PAINT OR PRESERVATIVE.

MAINTENANCE

GUARANTEE

CERTIFICATE.

FINAL ACCEPTANCE

APPROVED COLOUR AND STYLE OF

CONCRETE UNIT PAVERS OR PRE-CAST

BROOM CLEAN SAND INTO ALL JOINTS

"PAVE-EDGE" PREMANUFACTURED EDGING (OR APPROVED EQUAL) SET IN PLACE

BOUND BY AN ADJACENT HARD SURFACE

AFTER INGTALLATION AS PER THE

MANUFACTURER'S SPECIFICATIONS

ON ALL SIDES OF PAVER AREA NOT

FINISHED GRADE

GRANULAR 'A' BASE

SUBGRADE MATERIAL COMPACTED TO 95% S.P.D

COMPACTED TO 98% S.P.D.

COURSE SAND

CONCRETE SLABS AS SPECIFIED ON PLAN

BUTT JOINTS TIGHT AS DICTATED BY DESIGN

POURED-IN-PLACE CONCRETE WORK

BE AS DETAILED AND SPECIFIED ON THE DRAWINGS

THE CONTRACTOR SHALL OBTAIN WRITTEN APPROVAL OF FORMWORK PRIOR TO

THE STYLE, COLOUR, AND FINISH OF CONCRETE ELEMENTS SHALL BE APPROVED BY THE OWNER AND/OR LANDSCAPE ARCHITECT PRIOR TO THE COMMENCEMENT OF CONCRETE WORK.

ALL STRUCTURAL CONCRETE WORK SHALL CONFORM TO LOCAL BUILDING CODES AND REGULATIONS

WHERE APPLICABLE, THE CONTRACTOR SHALL OBTAIN WRITTEN APPROVAL FROM THE LANDSCAPE ARCHITECT OF ALL STRUCTURAL CONCRETE WORK BEFORE COMMENCING BRICKWORK, STONEWORK OR PAVING WORK.

ALL BRICKWORK, STONEWORK, AND CONCRETE UNIT PAVING SHALL BE AS DETAILED AND SPECIFIED ON THE DRAWINGS, UNLESS THE LANDSCAPE ARCHITECT AND/OR THE OWNER APPROVE SUBSTITUTIONS IN WRITING.

PRIOR TO STARTING THIS PORTION OF WORK, THE CONTRACTOR SHALL SUBMIT SAMPLES OF ALL PROPOSED BRICKWORK, STONEWORK, AND CONCRETE UNIT PAVERS FOR APPROVAL BY THE LANDSCAPE ARCHITECT AND/OR THE OWNER WITH RESPECT TO STYLE, COLOUR, AND FINISH. THE CONTRACTOR MAY ALSO BE ASKED TO SUBMIT SAMPLES OF ALTERNATIVES TO THE MATERIALS SPECIFIED ON THE DRAWINGS.

ALL BRICKWORK, STONEWORK, AND CONCRETE UNIT PAVING SHALL CONFORM TO LOCAL BUILDING CODES AND OTHER MUNICIPAL REQUIREMENTS.

ALL WOOD SHALL BE NO. 1 GRADE DRESSED CLEAR CEDAR, PRESSURE-TREATED RED PINE, OR PRESSURE-TREATED JACK PINE, AS SPECIFIED ON THE DRAWINGS.

CLEAR CEDAR OR SPECIALTY WOODS SHALL BE STAINED WITH TWO (2) COATS OF

THE CONTRACTOR SHALL SUBMIT SAMPLES OF ALL PROPOSED FINISHES FOR APPROVAL BY THE LANDSCAPE ARCHITECT AND/OR THE OWNER PRIOR TO ITS APPLICATION. THE CONTRACTOR MAY ALSO BE ASKED TO SUBMIT SAMPLES OF

ALTERNATIVES TO THE MATERIALS OR FINISHES SPECIFIED ON THE DRAWINGS

THE CONTRACTOR SHALL MAINTAIN ALL LANDSCAPED AREAS FOR A PERIOD OF FOUR (4) GROWING MONTHS FROM THE DATE OF SUBSTANTIAL COMPLETION.

MAINTENANCE SHALL INCLUDE: * PROPER IRRIGATION TO ENSURE OPTIMUM GROWTH OF TREES, SHRUBS, AND SOD

* GRASS MOWING TO MAINTAIN AN APPROXIMATE HEIGHT OF 50mm * THE CULTIVATION AND WEEDING OF TREE PITS AND PLANTING BEDS * INSECT AND DISEASE CONTROL

AT THE END OF THE SPECIFIED MAINTENANCE PERIOD, PROVIDED ALL PLANT MATERIAL IS ALIVE AND IN A HEALTHY GROWING CONDITION, THE OWNER WILL ASSUME THE RESPONSIBILITY OF MAINTAINING THE LANDSCAPE WORK.

WRITTEN NOTICE OF PERFORMANCE ACCEPTANCE BY THE LANDSCAPE ARCHITECT FOR SUBSTANTIAL COMPLETION OF THE PROJECT LANDSCAPE WORKS SHALL MARK THE START OF THE GUARANTEE PERIOD.

SHOULD LOCAL LAW REQUIRE MUNICIPAL ACCEPTANCE, THE LANDSCAPE ARCHITECT WILL SUBMIT THE SUBSTANTIAL COMPLETION CERTIFICATE TO THE MUNICIPALITY SO THAT THEY MAY PROCEED TO INSPECT THE WORK, ISSUE THEIR PERFORMANCE ACCEPTANCE CERTIFICATE, AND REDUCE THE AMOUNT OF SECURITIES.

ALL PLANT MATERIAL SHALL BE GUARANTEED FOR TWO (2) YEAR FROM THE DATE ON THE PERFORMANCE ACCEPTANCE CERTIFICATE ISSUED BY THE LANDSCAPE ARCHITECT. PLANTS THAT EXPIRE OR OTHERWISE FAIL TO THRIVE

DURING THE GUARANTEE PERIOD SHALL BE REPLACED AT THE EXPENSE OF THE CONTRACTOR.

SIMILARLY, ALL OTHER LANDSCAPE WORK PERFORMED UNDER THIS CONTRACT SHALL BE FULLY GUARANTEED FOR ONE (1) YEAR FROM THE DATE OF PERFORMANCE. ACCEPTANCE BY THE LANDSCAPE ARCHITECT.

ALL WORK SHALL BE INSPECTED AT THE END OF THE GUARANTEE PERIOD BY THE LANDSCAPE ARCHITECT. ANY DEFICIENCIES SHALL BE RECTIFIED BY THE CONTRACTOR TO THE SATISFACTION OF THE LANDSCAPE ARCHITECT AND THE OWNER. THE LANDSCAPE ARCHITECT WILL THEN ISSUE A FINAL ACCEPTANCE DEDICIONATE

SHOULD LOCAL LAW REQUIRE MUNICIPAL ACCEPTANCE, THE LANDSCAPE ARCHITECT WILL SUBMIT THE FINAL ACCEPTANCE CERTIFICATE TO THE MUNICIPALITY SO THAT THEY MAY PROCEED TO INSPECT THE WORK, GIVE FINAL APPROVAL, AND RELEASE ALL OUTSTANDING LANDSCAPE SECURITIES.

NTS

ABAL H301-070613

PRESSURE TREATMENT SHALL BE FACTORY-APPLIED COPPER CHROME

ARSENATE OR EQUAL, AS PER CSA-080 SPECIFICATIONS.

PERFORMANCE ACCEPTANCE

(SUBSTANTIAL COMPLETION)

BRICKWORK, STONEWORK & CONCRETE UNIT PAVING

POURING CONCRETE, ALL CONCRETE, STEEL REINFORCING, AND FORMWORK SHALL

PRIOR TO COMMENCING WORK, THE CONTRACTOR SHALL: 1. FAMILIARIZE HIMSELF WITH THE PLANS, DETAILS, AND SPECIFICATIONS OF THIS PROJECT, VISIT THE SITE TO ASCERTAIN AND TAKE ACCOUNT OF

- EXISTING 2. CONDITIONS AND ANY DEVIATIONS FROM THE PLANS IN WORK BY OTHERS, AND
- 3. FINALIZE ALL DESIGN ALTERNATIVES IN CONSULTATION WITH THE LANDSCAPE ARCHITECT.

- PRIOR TO EXCAVATING, THE CONTRACTOR SHALL VERIFY THE LOCATION OF ALL UNDERGROUND UTILITIES. IN THE EVENT OF A CONFLICT BETWEEN A PROPOSED TREE LOCATION AND AN UNDERGROUND SERVICE, THE EXACT LOCATION OF THE TREE SHALL BE DETERMINED ON SITE BY THE LANDSCAPE ARCHITECT.

THE CONTRACTOR SHALL, AT HIS OWN EXPENSE, REPAIR ANY DAMAGE TO EXISTING UTILITIES, STRUCTURES, FACILITIES, ETC. DONE IN THE PERFORMANCE OF HIS

ALL SITE WORK SHALL CONFORM TO THE SCANADIAN NATIONAL MASTER CONSTRUCTION SPECIFICATIONS, A COPY OF WHICH CAN BE OBTAINED FROM CONSTRUCTION SPECIFICATIONS CANADA, Tel. (416) 777-2198, Fax. (416) 777-219, Email. info@csc-dcc.ca. IT IS THE RESPONSIBILITY OF THE CONTRACTOR TO BE THOROUGHLY FAMILIAR WITH THESE

ALL PLANTS SHALL BE INSTALLED TRUE TO SPECIFIED NAMES, SIZES, GRADES, ETC. AND SHALL CONFORM TO THE STANDARDS OF THE CANADIAN NURSERY TRADES

IN THE EVENT OF A DISCREPANCY IN PLANT QUANTITY BETWEEN THE PLANTING PLAN AND THE PLANT LIST, THE PLANTING PLAN SHALL GOVERN.

THE CONTRACTOR SHALL MAKE PLANTS AVAILABLE FOR INSPECTION BY THE LANDSCAPE ARCHITECT PRIOR TO INSTALLATION. MATERIAL NOT CONFORMING TOTHE SPECIFICATIONS SHALL BE REPLACED AT THE EXPENSE OF THE CONTRACTOR.

PLANT SUBSTITUTIONS MUST BE APPROVED IN WRITING BY THE OWNER OR THE LANDSCAPE ARCHITECT PRIOR TO DELIVERY OF THE MATERIAL ON SITE.

THE LANDSCAPE ARCHITECT MAY, UPON COMPLETION OF THE WORK AND NOTWITHSTANDING PRIOR APPROVAL AT SOURCE, REJECT PLANT MATERIAL NOT CONFORMING TO THE SPECIFICATIONS.

THE CONTRACTOR SHALL USE STANDARD INDUSTRY METHODS FOR PLANTING TREES. TREES SHALL BE TURNED TO GIVE THE BEST APPEARANCE; THEY SHALL ALSO BE GUYED AND STAKED IMMEDIATELY AFTER PLANTING AND AS DETAILED ON THE DRAWINGS.

THE CONTRACTOR SHALL BACKFILL TREE PITS AND PLANTING BEDS TO SPECIFIED

THE CONTRACTOR SHALL BACKFILL TREE PTTS AND PLANTING BEDS TO SPECIF DEPTHS WITH EITHER PRE-MIXED TOPSOIL (VIZ., "TRIPLE-MIX") OR A MIXTURE COMPRISED OF: 6 PARTS SANDY LOAM 1 PART FINELY PULVERIZED CANADIAN PEAT MOSS 1 PART WELL-ROTTED FARM MANURE, WITH "AGRIFORM" 20-10-5 TABLETS (OR APPROVED EQUAL) ADDED ACCORDING TO THE MANUFACTURER'S SPECIFICATIONS.

THE CONTRACTOR SHALL CONSTRUCT TREE PITS AND SHRUB BEDS WITH SOIL SAUCERS, MULCH, AND SUBSURFACE DRAINAGE AS DETAILED.

THE CONTRACTOR SHALL CONSTRUCT SHRUB BEDS IN CONTINUOUS FORMS, THE SHAPE OF WHICH SHALL BE APPROVED BY THE LANDSCAPE ARCHITECT AND/OR OWNER. ON SLOPES, SHRUB BEDS SHALL BE FASHIONED TO ALLOW FOR PROPER DRAINAGE.

THE CONTRACTOR SHALL PLACE 150mm OF RICH TOPSOIL ON APPROVED SUBGRADES. TOPSOIL SHALL BE IMPORTED WHERE REQUIRED. 10-6-4 FERTILIZER SHALL BE APPLIED ACCORDING TO THE MANUFACTURER'S INSTRUCTIONS AT A RATE OF 7.32 kg/100m² FOR SODDED AREAS: THE MIXTURE AND RATE OF APPLICATION SHALL BE ADJUSTED FOR SEEDED AREAS.

MINOR GRADE DEFICIENCIES AND IRREGULARITIES SHALL BE ELIMINATED PRIOR TO SODDING.

THE CONTRACTOR SHALL SOD ALL AREAS SO INDICATED ON THE DRAWINGS. SOD SHALL BE FRESHLY CUT NO.1 GRADE NURSERY-GROWN TURF 50-75mm THICK.

SOD SHALL BE PLACED ON PREPARED TOPSOIL, WITH JOINTS STAGGERED AND SECTIONS ABUTTED TIGHTLY. IMMEDIATELY AFTER LAYING, IRRIGATION SUFFICIENT TO ENSURE MOISTURE PENETRATION TO A DEPTH OF 100mm SHALL BE APPLIED.

ĊĔĿĊĔĿĊĔĿĊĔĿĊĔĿĊĔĿĊĔĿĊĔĿĊĔ

CONCRETE UNIT PAVER DETAIL

HAND TAMP OUTER EDGE OF ASPHALT TO 45' WHERE ASPHALT MEETS SOFT LANDSCAPING

PATHWAY WIDTH

ABPHALT MULTI-USE PATHWAY

200

20% SLOPE MIN Laborated highlighting

C. D. D. W. B. D. W. M. W. W.

0.0 6000000

TION OF CROSS SLOPE SHALL BE ADJUSTED TO SUIT GRADING

SEPTIM

APRO TOWN DATE: A DRAWN: DW SCALE: N

1121

STD. No.

-87 c + 9

PATHWAY DETAIL

MAY BE REQUIRED TO SUIT C

EXCAVATE ALL TOPSOIL AND ORGANIC MATTER UNDER TRAIL BED STANDARD DETAIL REFLECTS IDEAL SUBGRADE CONDITIONS ON COMPACTED WELL DRAINED SOIL ADDITIONAL GRANULAR MATERIAL

ALL GRANULAR WORK TO BE IN ACCORDANCE WITH OP55 314 ALL HOT MIX ASPHALT WORK FOR PATHWAYS SHALL BE IN

ACCORDANCE WITH OPSS 311. ROLL ASPHALT CONTINUOUSLY TO DENSITY NOT LESS THAN 97%. MARSHALL BULK DENSITY.

DO NOT BACKFILL AGAINST ASPHALT FOR MIN. OF 48 HOURS.

DIMENSIONS IN MILLIMETERS UNLESS OTHERWISE NOTED

SEE FATHWAY

ADJACENT FINISHED GRADE

DETAIL

TYPICAL INSTALLATION

WHERE DEEMED APPROPRIATE BY THE TOWN, THE PATHWAY WIDTH

MAY BE REDUCED TO 2.4m FOR

PEEDER/LINKING TRAILS AND TH MOW STRIP MAY BE REDUCED TO 0.6m TO RESPOND TO SITE

CONSTRAINTS OR TO PROTECT VEGETATION

50mm HL3 HOT MOX ASPHAL

COMPACTED TO 97% MARSHALL BULK DENSITY

UNDISTURBED OR COMPACTED SUBGRADE TO 95% SPMDD.

GRANLLAR'A

COMPACTED -

NOTES:

REVISION

TOWN OF COLLINGWOOD

ASPHALT MULTI-USE PATHWAY

ASPHALT PATHWAY DETAIL

UPDATED NOTES & DIMENSIONS


TOWN OF COLLINGWOOD DETAIL

(8

SOD FOR SUNNY, EXPOSED AREAS SHALL BE 50% KENTUCKY BLUEGRASS AND 50% MERION BLUEGRASS. SOD FOR SHADED AREAS SHALL BE 50% NUGGET KENTUCKY BLUEGRASS AND 50% CREEPING RED FESCUE.

SOD SHALL BE MACHINE ROLLED TO ENSURE UNIFORM CONTACT WITH TOPSOIL. SOD ON ALL SLOPES SHALL BE PEGGED WHERE REQUIRED.


SPECIFICATIONS AND THEIR IMPLICATIONS FOR THIS PROJECT.

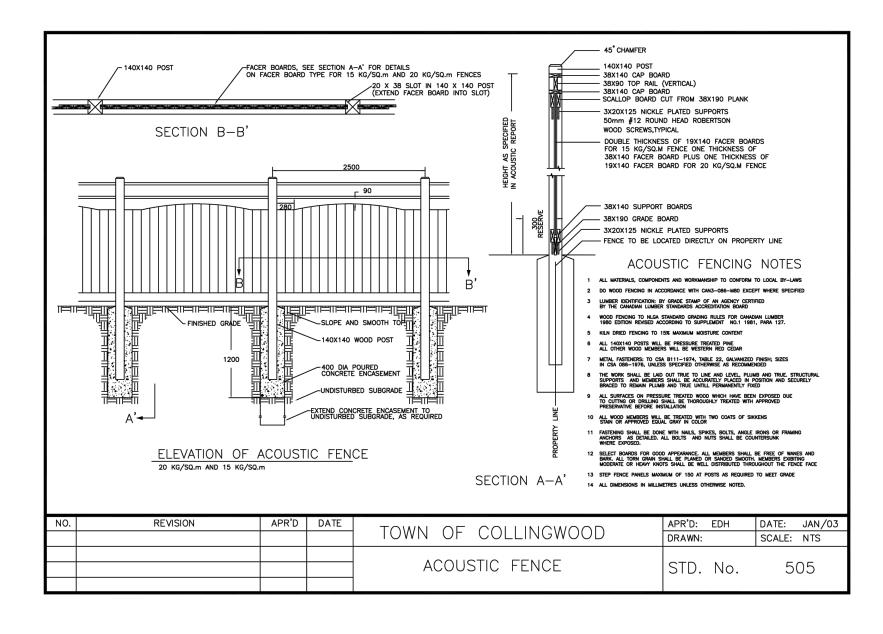

ACOUSTIC WOOD FENCE DETAIL TOWN OF COLLINGWOOD DETAIL


NTS

NTS

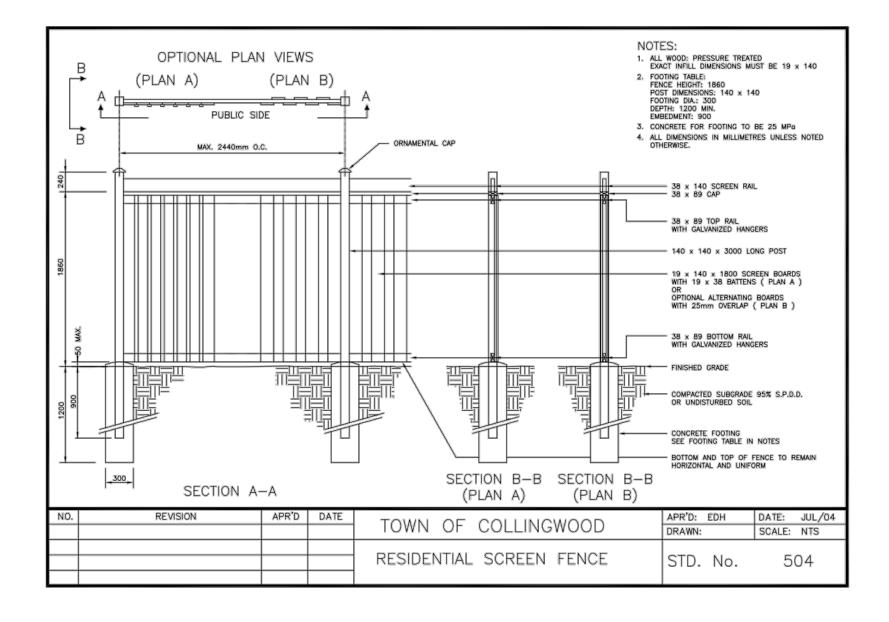


RESIDENTIAL SCREEN FENCE DETAIL

TOWN OF COLLINGWOOD DETAIL

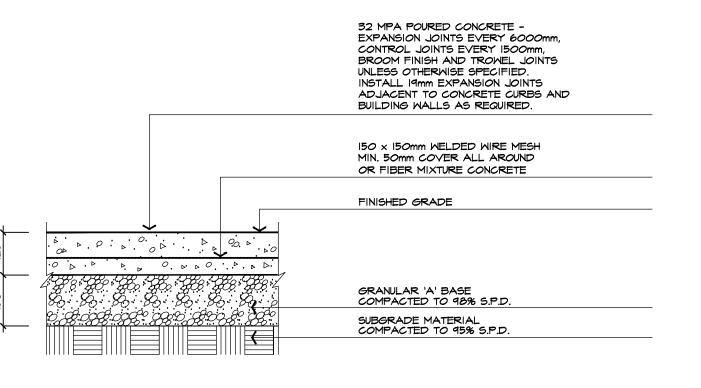


6


2

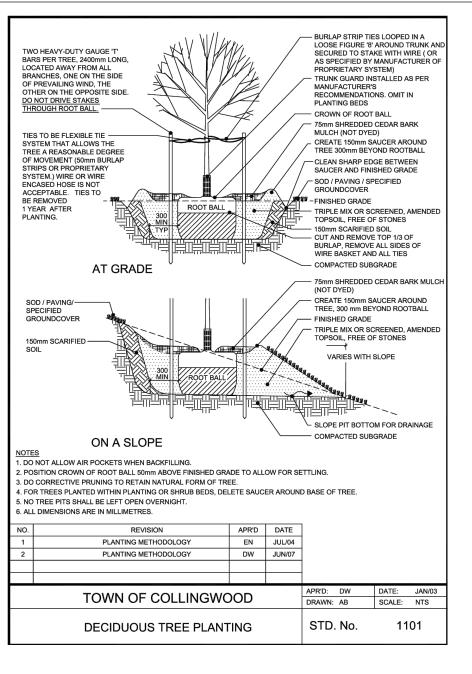


DECIDUOUS TREE PLANTING DETAIL NTS

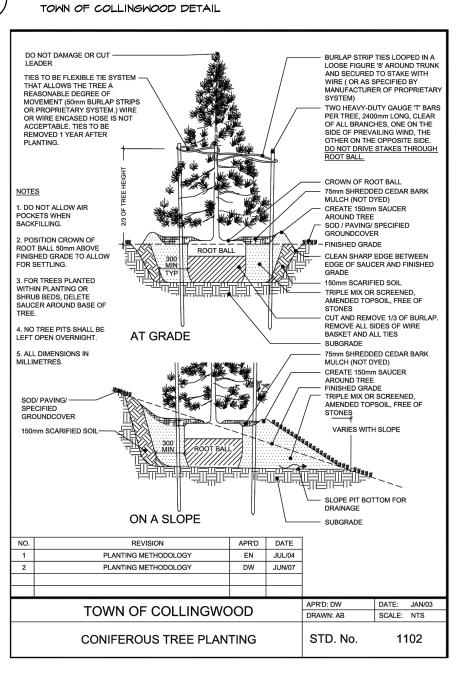


CONIFEROUS TREE PLANTING DETAIL NTS TOWN OF COLLINGWOOD DETAIL

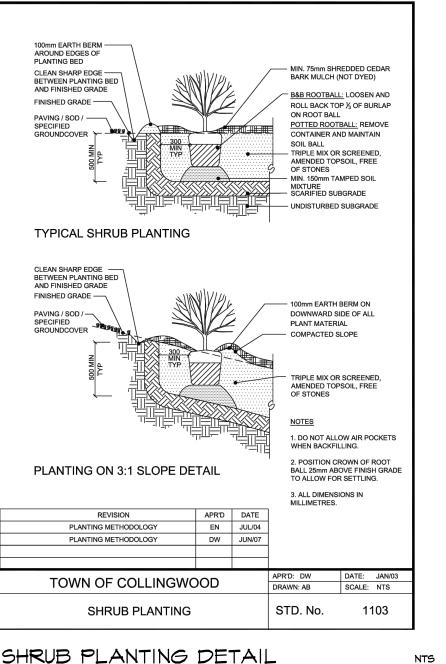

SHRUB PLANTING DETAIL TOWN OF COLLINGWOOD DETAIL

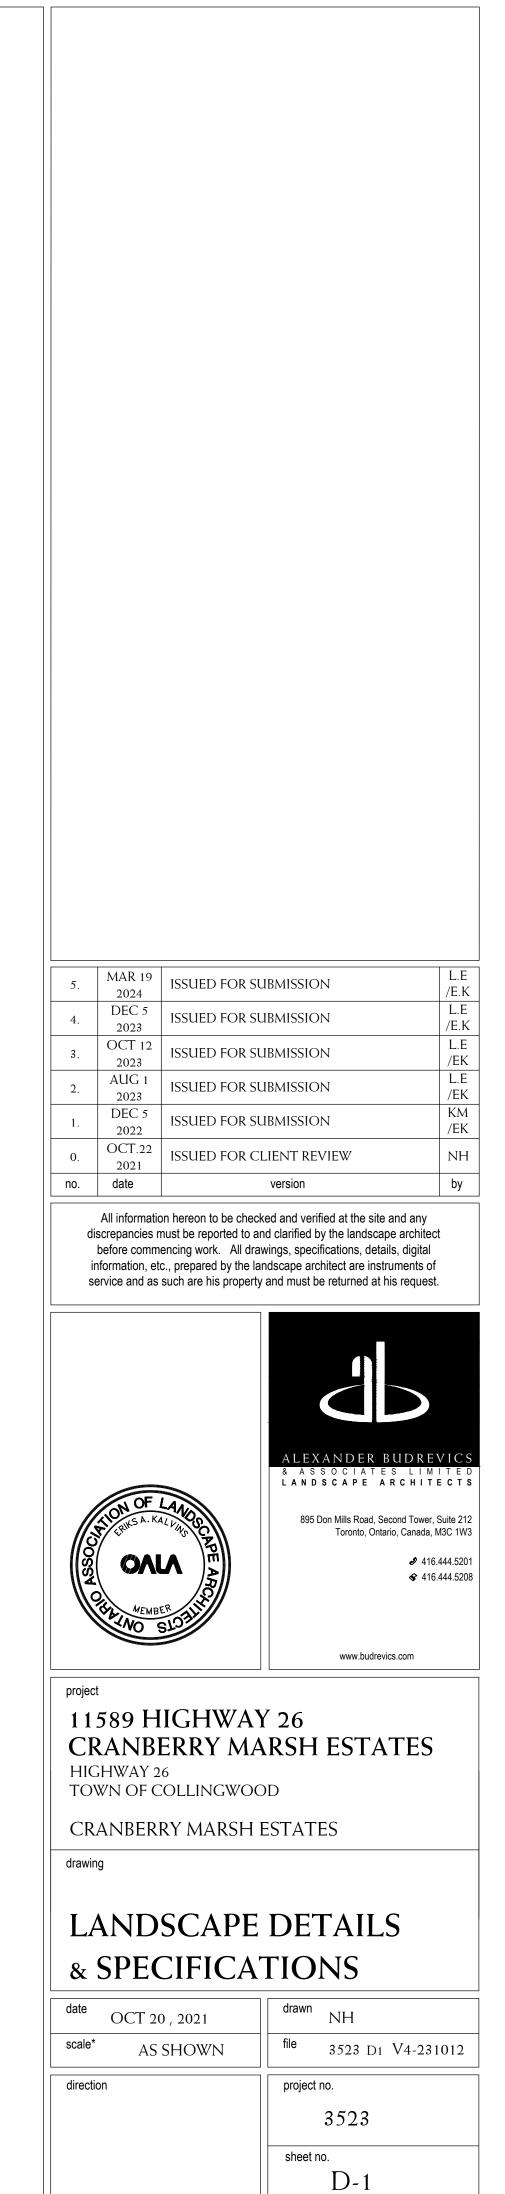

*NOTED SCALE IS APPLICABLE ONLY WHEN PRINTED ON ARCH D (24"x36") SIZE SHEET

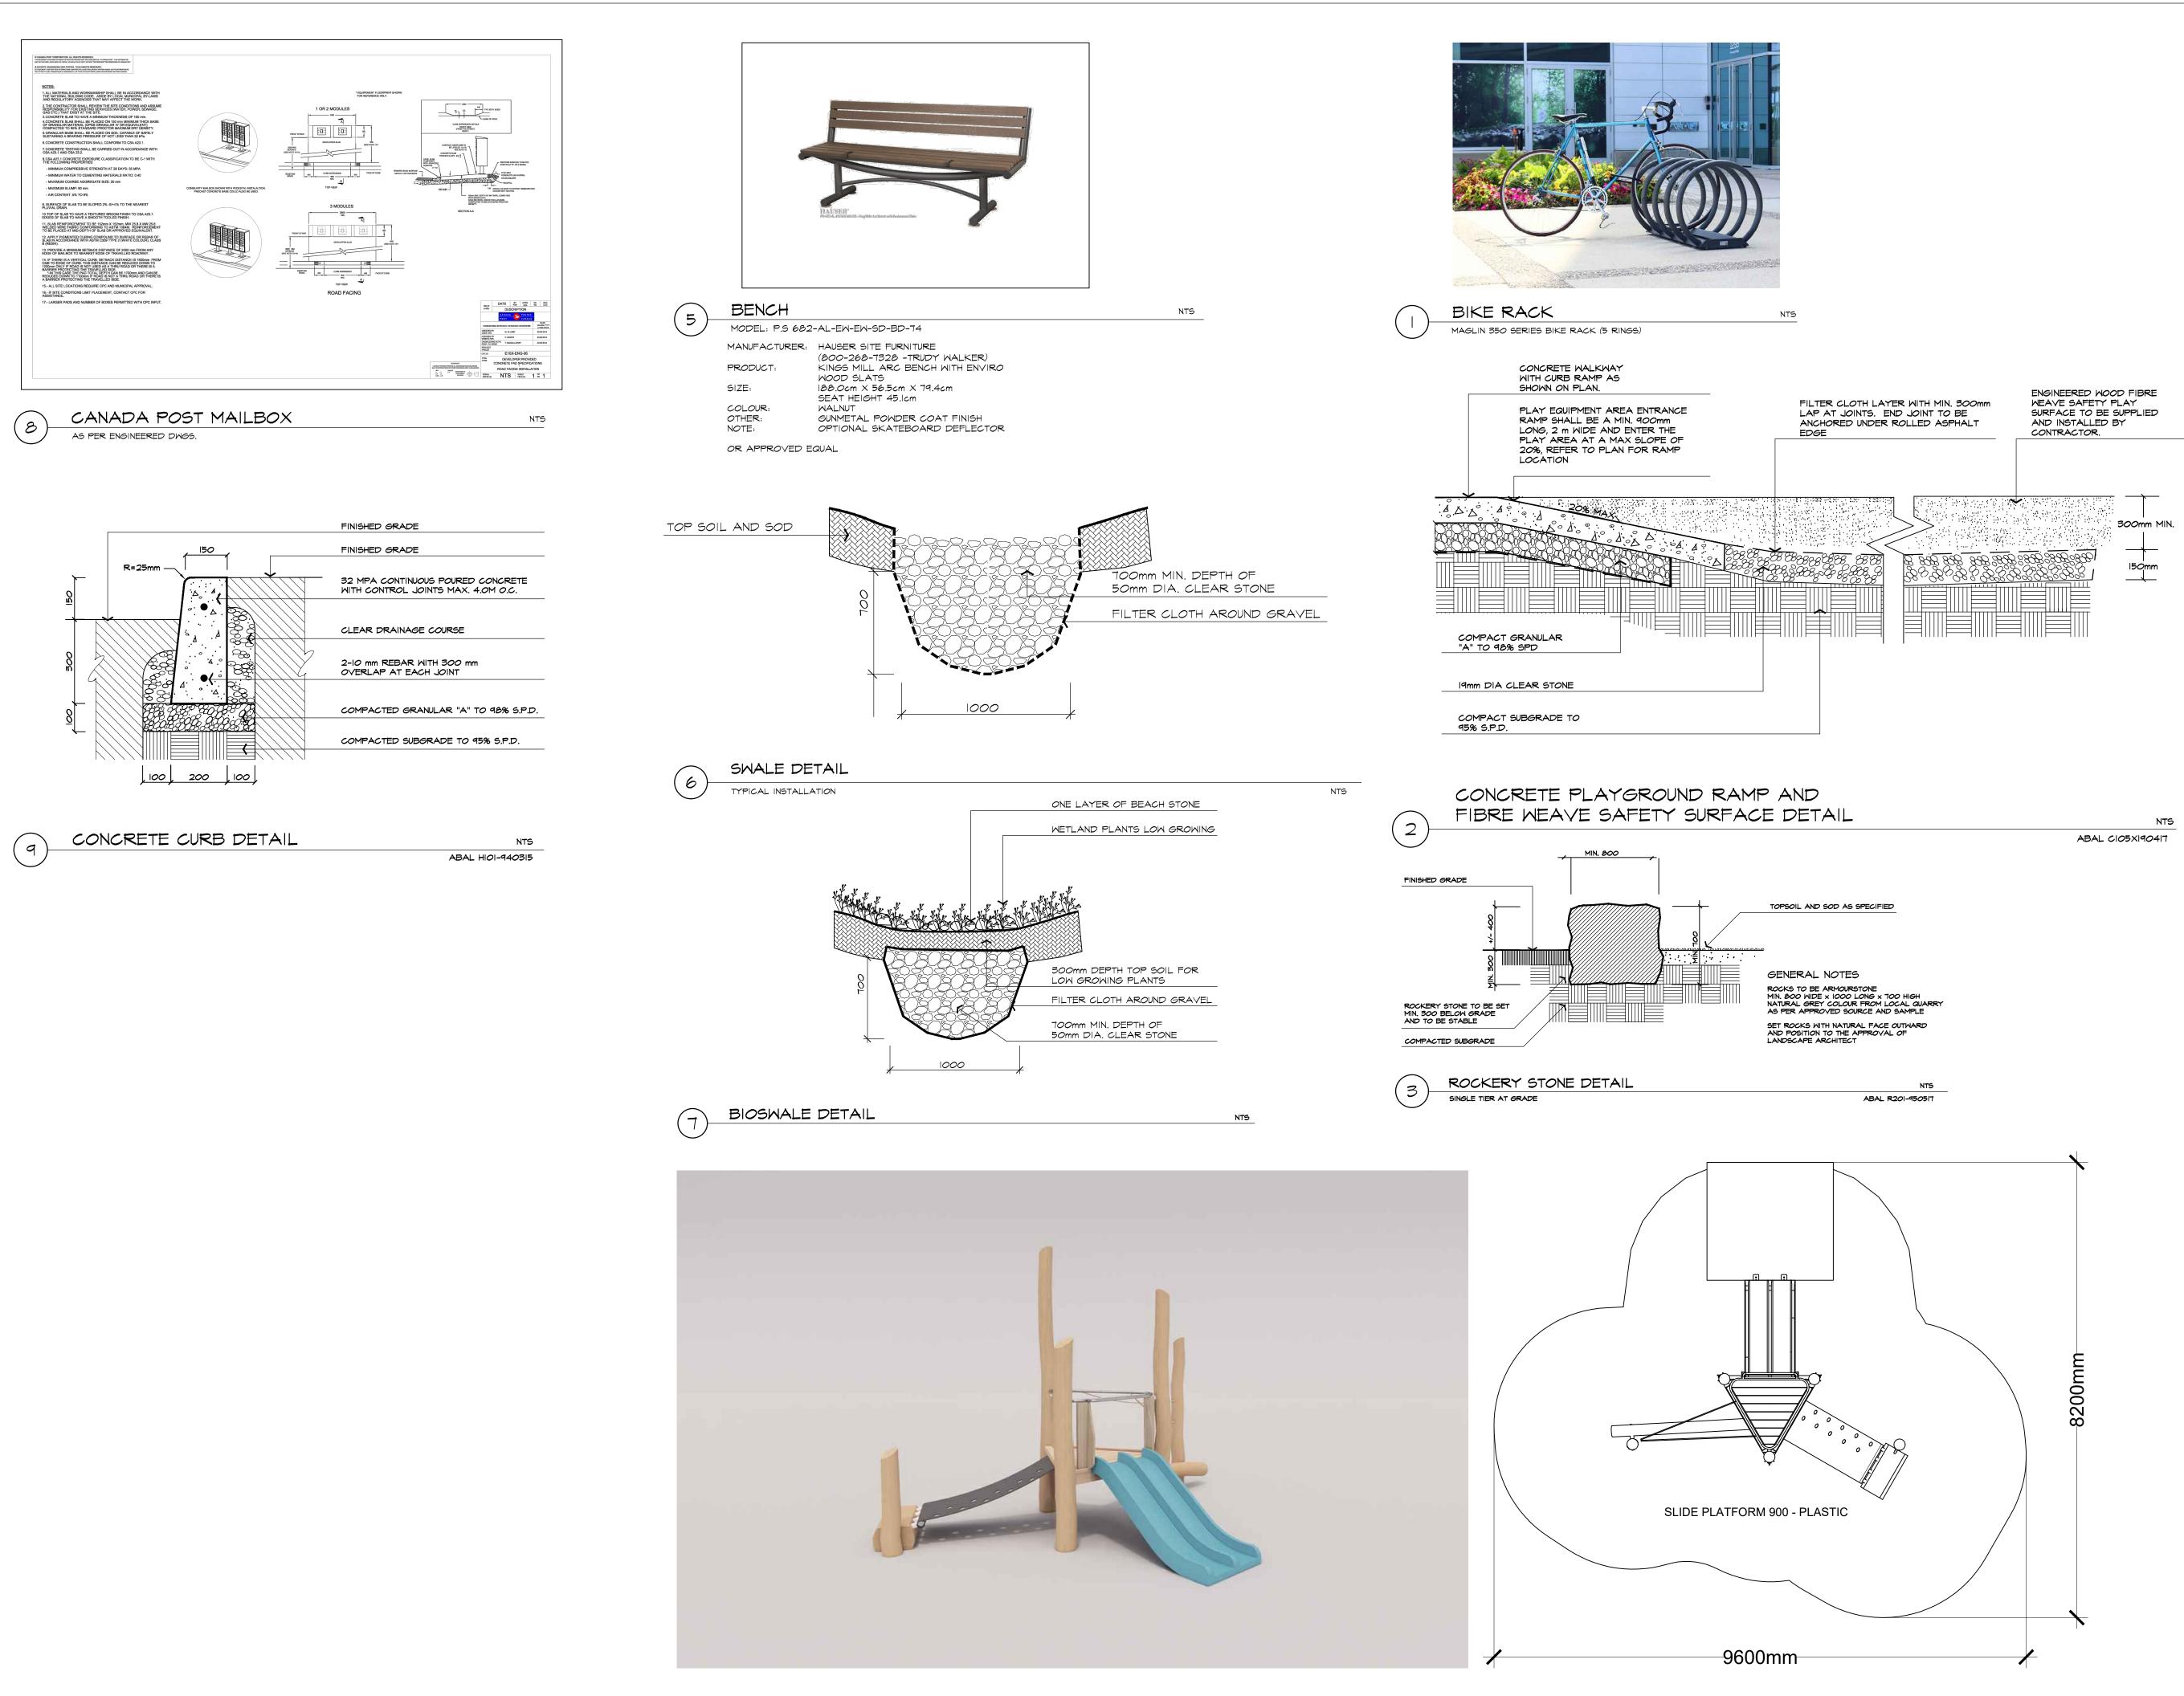







PLAY EQUIPMENT

EARTRHSCAPE "SLIDE PLATFORM 900-(PLASTIC SLIDE)" PLAYGROUND SHALL COMPLY WITH THE CANADIAN STANDARDS ASSOCIATION'S CAN/ CSA-Z614-20: CHILDREN'S PLAYGROUND EQUIPMENT AND SURFACING AND THE ACCESSIBILITY FOR ONTARIANS WITH DISABILITIES ACT (AODA)- PART 4.1 DESIGN OF PUBLIC SPACES STANDARD

5.	MAR 19 2024	ISSUED FOR SUBMISSION	L.E /E.K
4.	DEC 5 2023	ISSUED FOR SUBMISSION	L.E /E.K
3.	OCT 12 2023	ISSUED FOR SUBMISSION	L.E /EK
2.	AUG 1 2023	ISSUED FOR SUBMISSION	L.E /EK
1.	DEC 5 2022	ISSUED FOR SUBMISSION	KM /EK
0.	OCT.22 2021	ISSUED FOR CLIENT REVIEW	NH
no.	date	version	by
	•	•	

All information hereon to be checked and verified at the site and any discrepancies must be reported to and clarified by the landscape architect before commencing work. All drawings, specifications, details, digital information, etc., prepared by the landscape architect are instruments of service and as such are his property and must be returned at his request.



11589 HIGHWAY 26 CRANBERRY MARSH ESTATES HIGHWAY 26

TOWN OF COLLINGWOOD

CRANBERRY MARSH ESTATES

drawing


NTS

project

LANDSCAPE DETAILS

date OCT 20 , 2021	drawn NH
scale* AS SHOWN	file 3523 D2 V4-231012
direction	project no.
	3523
	sheet no. D-2


*NOTED SCALE IS APPLICABLE ONLY WHEN PRINTED ON ARCH D (24"x36") SIZE SHEET

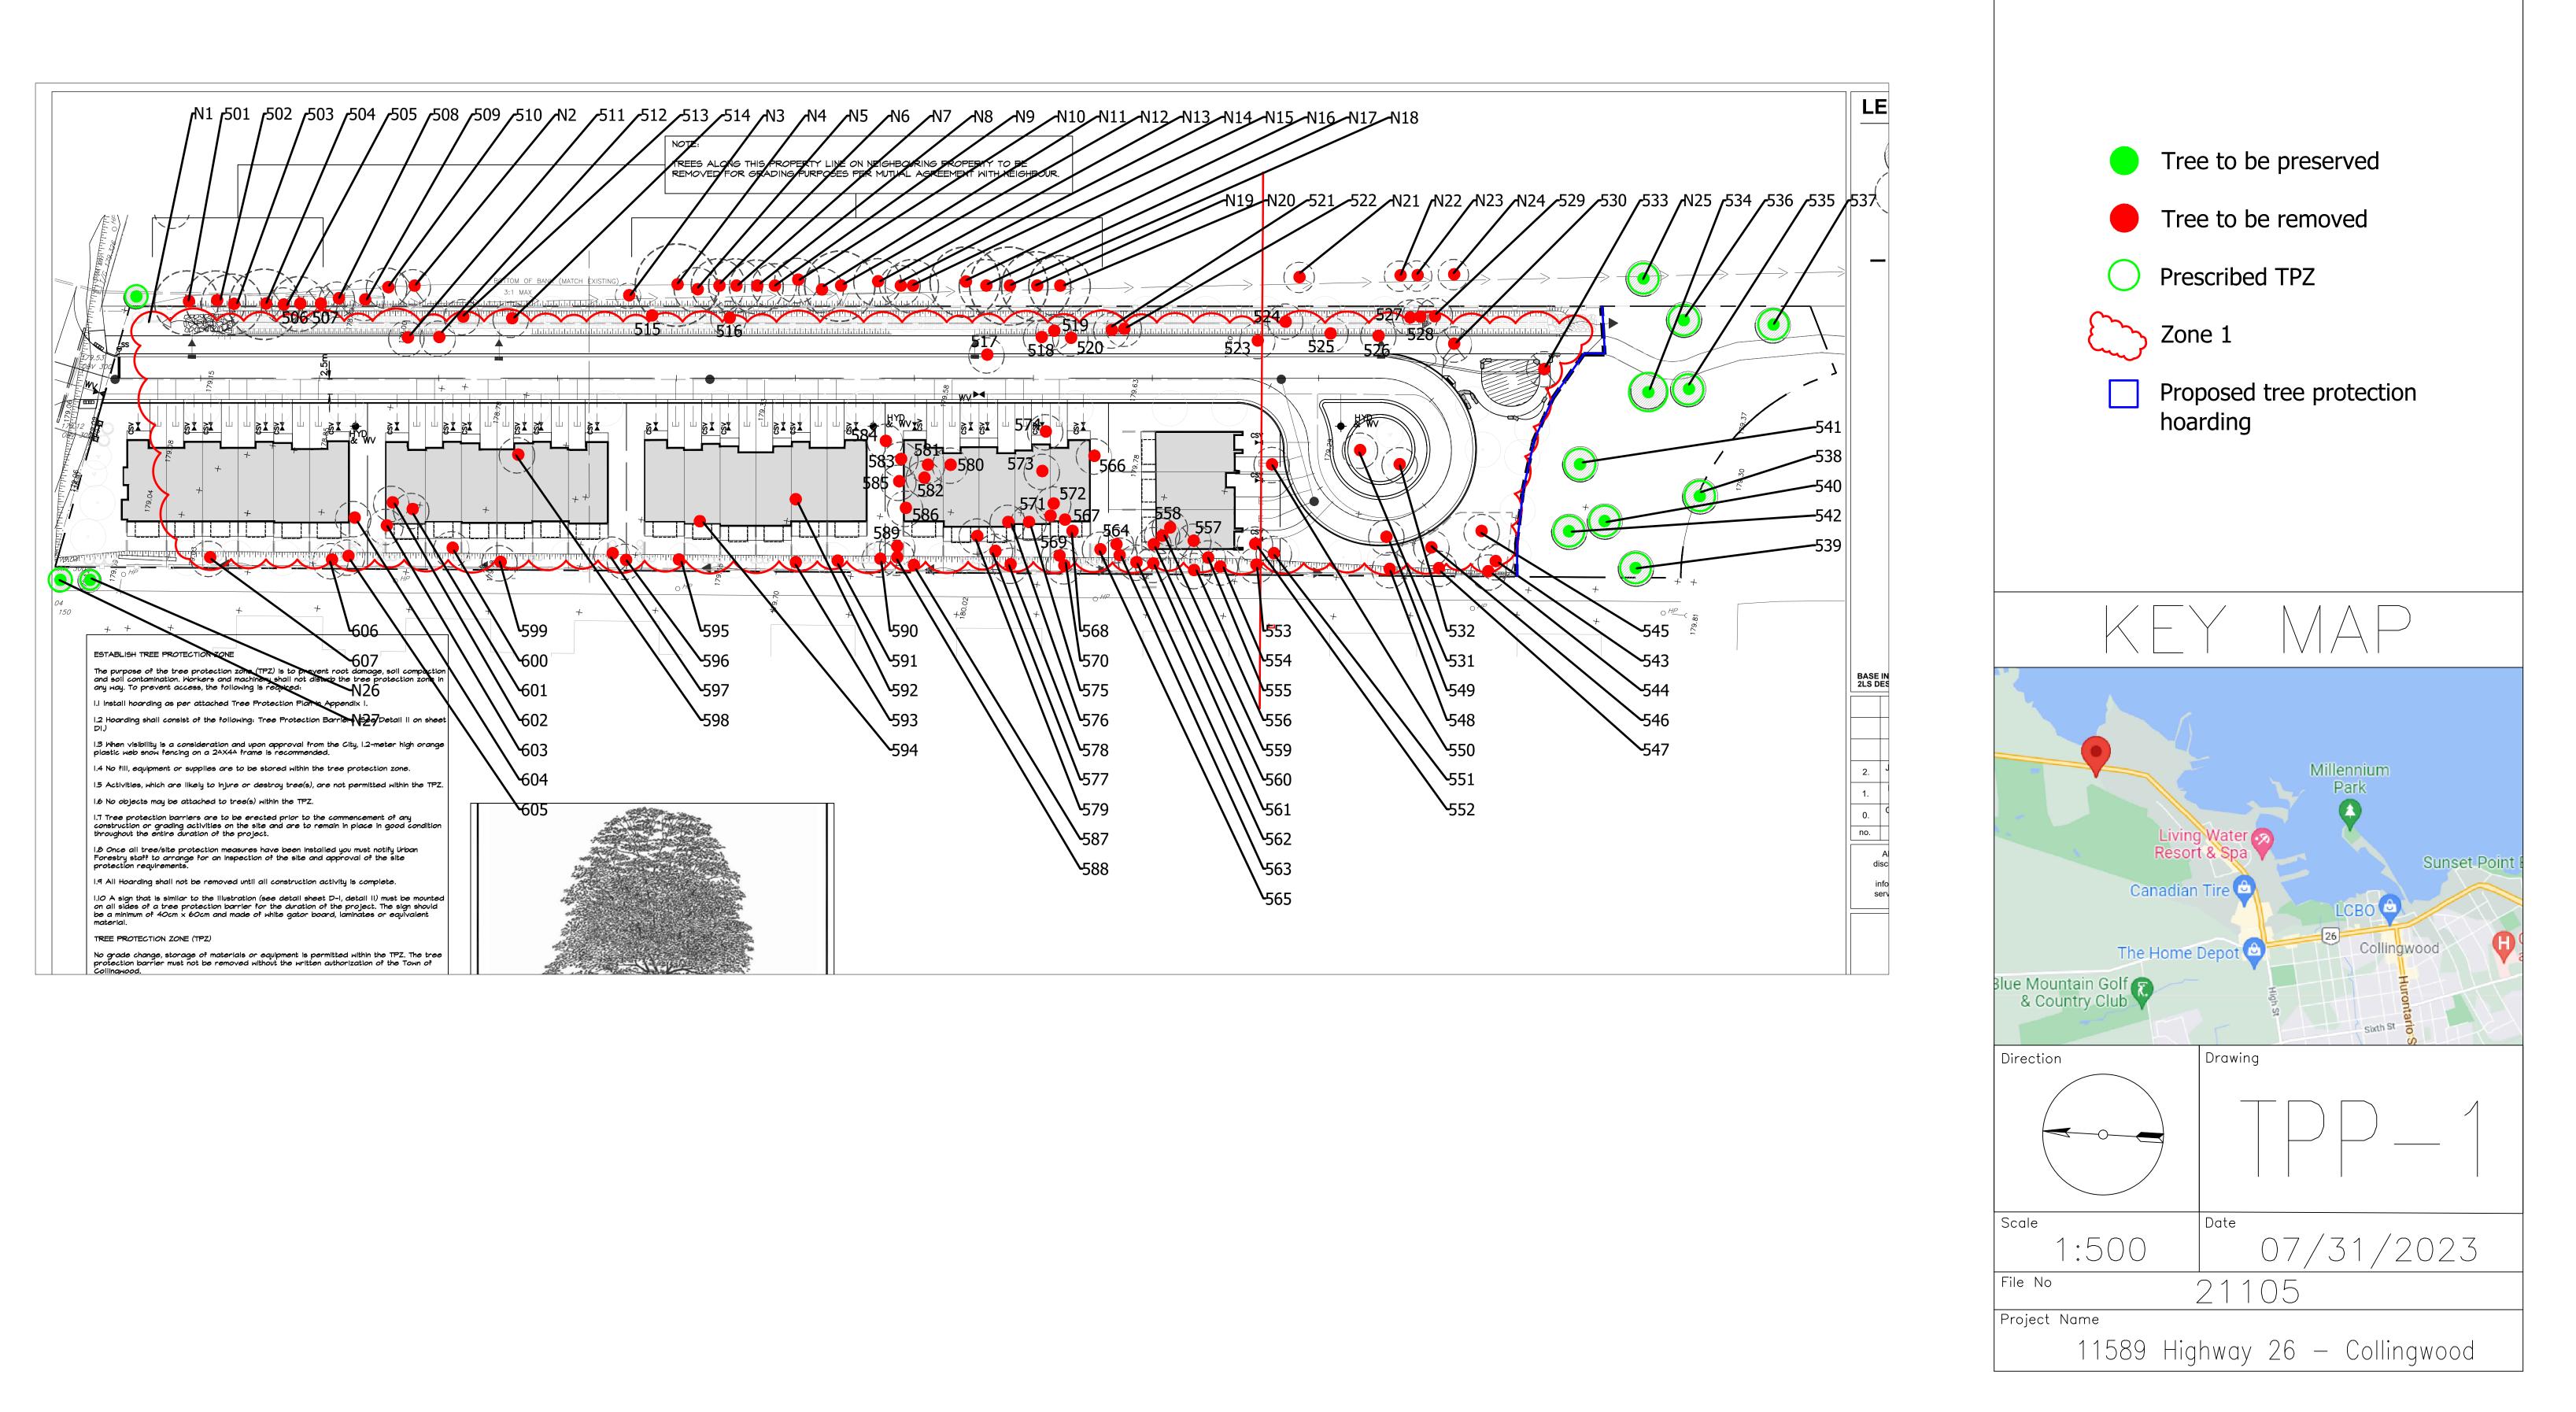







BLOCK 4 & 5 - FRONT

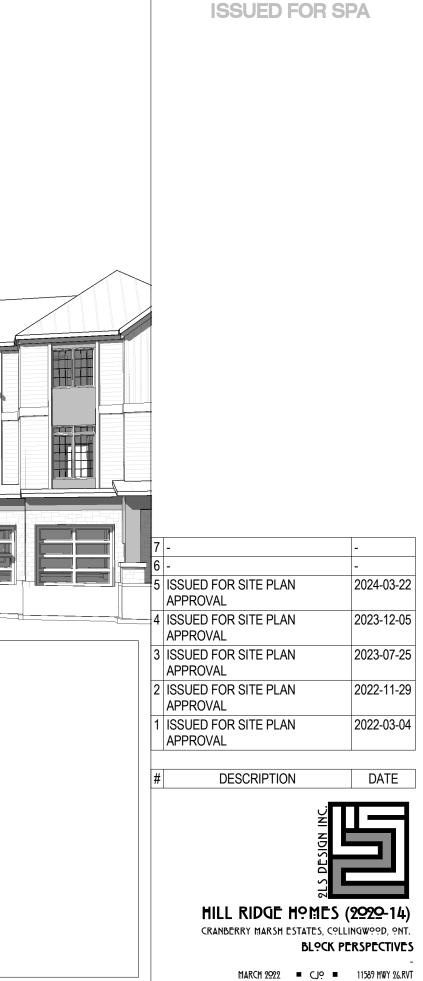



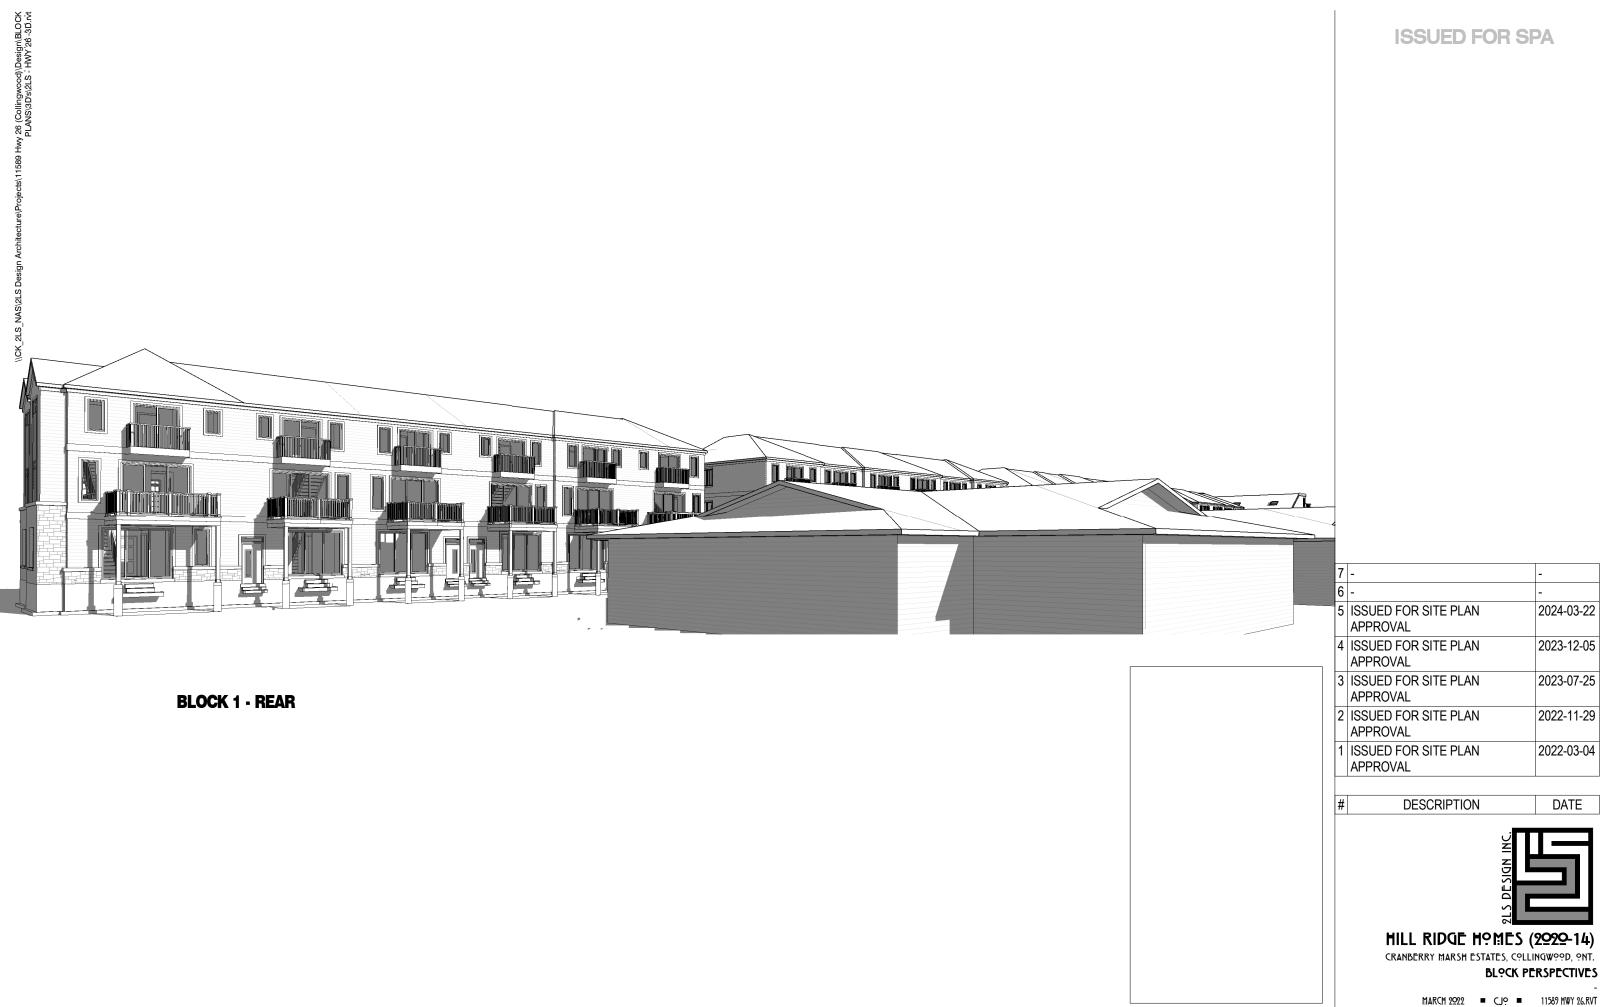

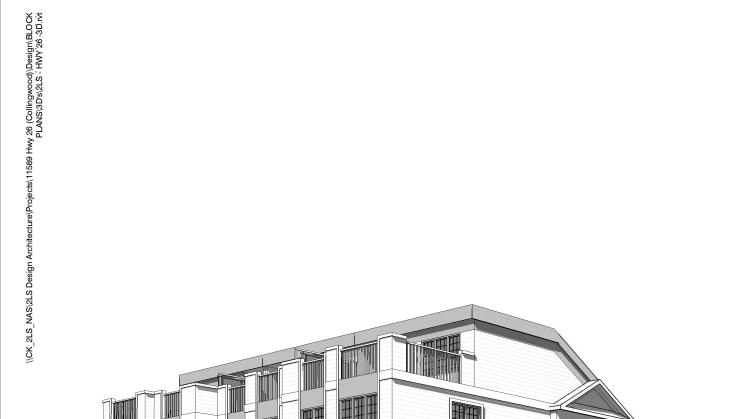



BLOCK 5 - FRONT @ STREET

	7	-	-
	6	-	-
	5	ISSUED FOR SITE PLAN APPROVAL	2024-03-22
_	4	ISSUED FOR SITE PLAN APPROVAL	2023-12-05
	3	ISSUED FOR SITE PLAN APPROVAL	2023-07-25
	2	ISSUED FOR SITE PLAN APPROVAL	2022-11-29
	1	ISSUED FOR SITE PLAN APPROVAL	2022-03-04
	#	DESCRIPTION	DATE
		HILL RIDGE HOMES (CRANBERRY MARSH ESTATES, COLLI BLOCK PE	. ,
		MARCH 2022 ■ CJO ■	- 11589 HWY 26.RVT

ISSUED FOR SPA



BLOCK 3 - REAR

7 -6 -5 ISSUED FOR SITE PLAN 2024-03-22 APPROVAL 4 ISSUED FOR SITE PLAN 2023-12-05 APPROVAL 3 ISSUED FOR SITE PLAN 2023-07-25 APPROVAL 2 ISSUED FOR SITE PLAN 2022-11-29 APPROVAL 1 ISSUED FOR SITE PLAN 2022-03-04 APPROVAL DESCRIPTION DATE # HILL RIDGE HOMES (2020-14) CRANBERRY MARSH ESTATES, COLLINGWOOD, ONT. BLPCK PERSPECTIVES MARCH 2922 CJ? 11589 HWY 26.RVT

ISSUED FOR SPA



ISSUED FOR SPA



2024-03-22

2023-12-05

2023-07-25

2022-11-29

2022-03-04

DATE


HILL RIDGE HOMES (2020-14)

CRANBERRY MARSH ESTATES, COLLINGWOOD, ONT. BLPCK PERSPECTIVES

MARCH 2922 = CJ? = 11589 HWY 26.RVT



BLOCK 1 - ENTRANCE

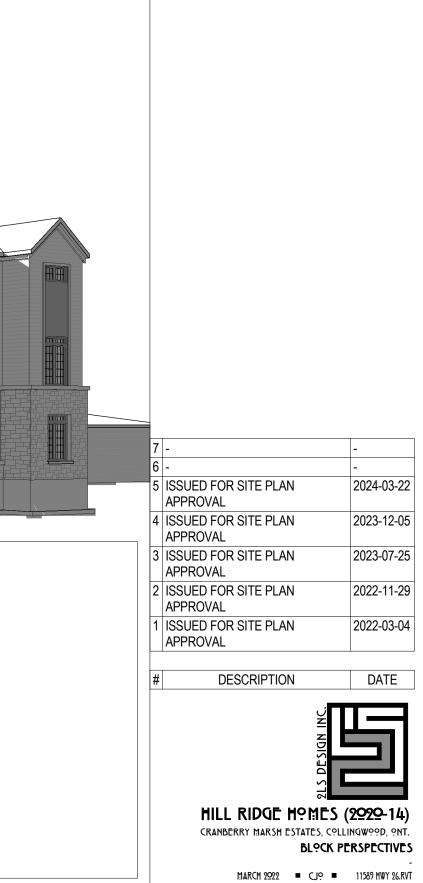


ISSUED FOR SPA



ISSUED FOR SPA





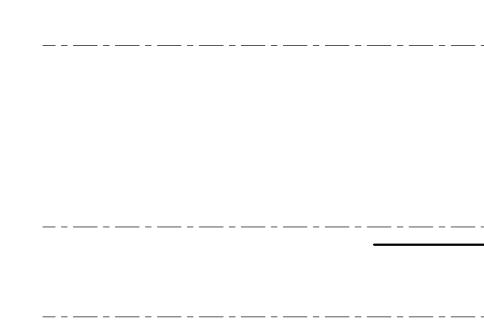

1 BLOCK 1 - RIGHT SIDE ELEVATION 3/16" = 1'-0"




<u>LOT 1 - UNIT 2002 (LOT MOD) (REV.)</u> <u>BLOCK 1</u>









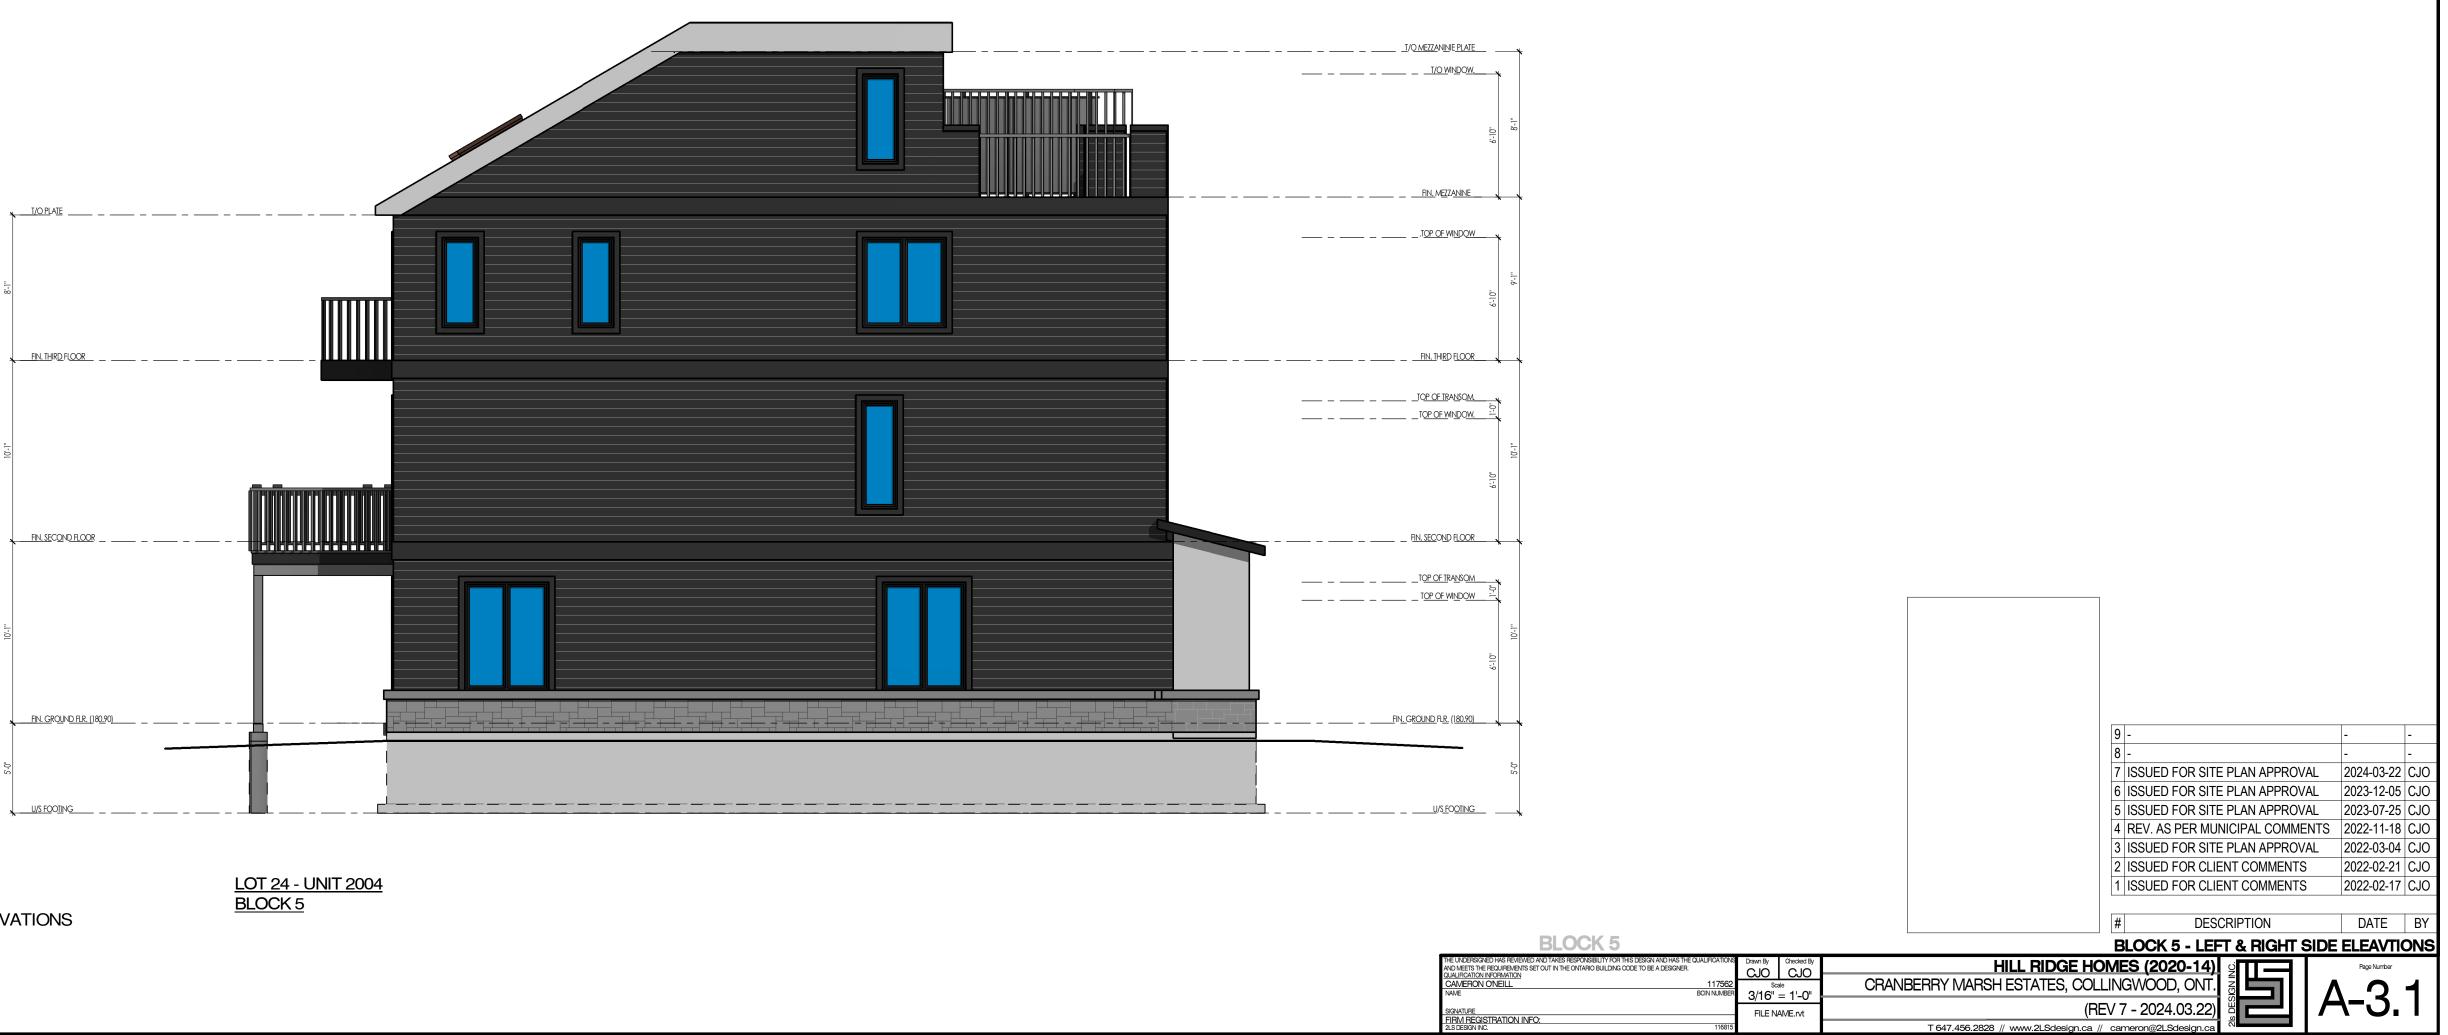

<u>LOT 26 - UNIT 2004 (MOD) (REV).</u> <u>BLOCK 5</u>